——8"W—— WATER LINE

——8"S——

ISSUE DATE:

EXPIRATION DATE:

WWR-19-00661

UTILITY COMPANY

CENTURY LINK

COX COMMUNICATIONS

ARIZONA PUBLIC SERVICE

CITY OF PHOENIX WATER

SOUTHWEST GAS CORPORATION

MCESD APPROVAL

ENVIRONMENTAL SERVICES DEPARTMENT

FOR REVIEW AND TO DETERMINE ANY POTENTIAL CONFLICTS.

THIS SET OF CONSTRUCTION PLANS HAVE BEEN SUBMITTED TO THE FOLLOWING UTILITY COMPANIES

COMPANY CONTACT

HOPE OLGVIN - 480.730.3845

CYNTHIA KEE - 602.371.7667

ESTHER MEDINA - 480.768.4474

KEN DEGRAFFENREID - 623.328.3423

DATE SUBMITTED

09.30.19

09.30.19

09.30.19

09.30.19

MARICOPA COUNTY

FIRE HYDRANT

WATER VALVE

WATER METER BOX

CHEROKEE ELEMENTARY SCHOOL

A PORTION OF THE NORTHWEST QUARTER OF SECTION 33, TOWNSHIP 3 NORTH, RANGE 4 EAST

RETENTION CALCULATIONS

0.0417

0.185

0.185

0.185

0.185

0.185

0.185

0.185

0.185

DRAINAGE AREA (AC)

1.71

0.42

0.57

2.28

2.21

2.94

COEFFICIENT

0.80

0.57

0.31

0.31

0.63

0.81

0.31

VOLUME REQUIRED (AC-FT) | VOLUME PROVIDED (AC-FT)

0.07 AC-FT

0.26 AC-FT

0.06 AC-FT

0.79 AC-FT

0.09 AC-FT

0.04 AC-FT

0.78 AC-FT

0.56 AC-FT

0.17 AC-FT

0.06 AC-FT

0.20 AC-FT

0.05 AC-FT

0.70 AC-FT

0.06 AC-FT

0.03 AC-FT

0.33 AC-FT

0.34 AC-FT


0.17 AC-FT

DESIGN STORM

FIRST FLUSH

100YR 2HR

IMPROVEMENT PLANS PARADISE VALLEY, ARIZONA OF THE GILA AND SALT RIVER BASE AND MERIDIAN, MARICOPA COUNTY, ARIZONA

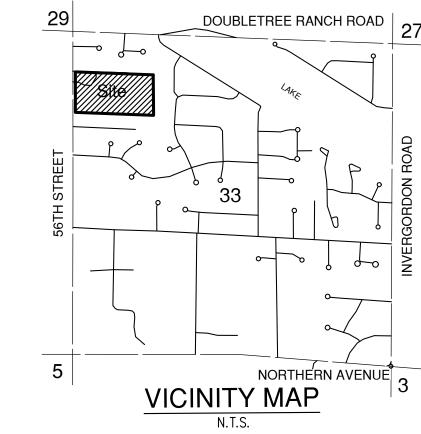

OWNER

SCOTTSDALE UNIFIED SCHOOL DISTRICT. 9288 E SAN SALVADOR DRIVE SCOTTSDALE, ARIZONA 85258 CONTACT: DENISS ROEHLER PHONE: 480.484.8503

ARCHITECT ORCUTT WINSLOW 2929 N CENTRAL AVENIE PHOENIX, ARIZONA 85012 PHONE: 602.257.1764 CONTACT:

CIVIL ENGINEER BOWMAN CONSULTING 1295 W WASHINGTON ST SUITE 108 TEMPE, AZ 85281

PHONE: 480.629.8830 ENGINEER: DAVID MALDONADO-CAMOU E-MAIL: dmaldonado@bowmanconsulting.com

BENCHMARK BRASS IN HANDHOLE FLUSH AT THE INTERSECTION OF DOUBLETREE RANCH ROAD AND 56th STREET, TOWN OF PARADISE VALLEY DATUM ELEVATION = 1339.448 (NAVD88)

BASIS OF BEARING

GILA AND SALT RIVER BASE AND MERIDIAN, MARICOPA COUNTY, ARIZONA, ACCORDING TO PLAT OF DOUBLE TREE RANCHOS AS RECORDED IN BOOK 120 OF MAPS, PAGE 33, M.C.R.

LEGAL DESCRIPTION

THE SOUTH HALF OF THE NORTHWEST QUARTER OF THE NORTHWEST QUARTER OF SECTION 33, TOWNSHIP 3 NORTH, RANGE 4 EAST OF THE GILA AND SALT RIVER BASE AND MERIDIAN, MARICOPA COUNTY ARIZONA;

EXCEPT THE WEST 40 FEET THEREOF AS CONVEYED TO MARICOPA COUNTY BY GRANT DEED RECORDED IN DOCKET 1269, PAGE 73. APN: 168-43-003

PROJECT DESCRIPTION

CHEROKEE ELEMENTARY SCHOOL IS A 19.43-ACRE PARCEL OF LAND LOCATED AT 8801 NORTH 56TH STREET IN PARADISE VALLEY, ARIZONA. THE SITE IS ZONED

SITE DATA

ADDRESS: 8801 NORTH 56TH STREET IN PARADISE VALLEY, AZ 85253. PARCEL NUMBER: 168-43-003 ZONING CLASSIFICATION: R-43S (PUBLIC SCHOOL) LOT AREA: 846,420.82sf 19.43Ac CONSTRUCTION YEAR: 1970

FEMA FLOOD ZONE INFORMATION

COMMI		PANEL # PANEL DATE	SUFFIX	DATE OF FIRM (INDEX DATE)	FIRM ZONE	BASE FLOOD ELEV. (IN AO ZONE, USE DEPTH)
0400	040040	04013C1755		01 /04 /0010		NI /A
040049	10/16/2013	L	01/24/2019	Х	N/A	

DRAINAGE STATEMENT

- 1. THE ULTIMATE STORM WATER OUTFALL IS LOCATED IN THE NORTHEAST CORNER OF THE LO WITH AN ELEVATION OF 1337.00 2. THE PROPOSED DEVELOPMENT DOES NOT IMPACT DRAINAGE CONDITIONS OF THE ADJOINING
- 3. THE SITE CURRENTLY PROVIDES MINIMAL RETENTION. ALL ONSITE STORMWATER RUNOFF UP TO THE 100-YEAR 2-HOUR STORM WILL BE RETAINED IN PROPOSED ONSITE RETENTION
- 5. ALL OFFSITE STORMWATER RUNOFF WILL BE ROUTED THROUGH THE SITE VIA A PROPOSED CHANNEL AND DISCHARGE AT THE SITE OUTFALL, FOLLOWING THE PRE-DEVELOPMENT DRAINAGE PATTERNS.

4. FIRST FLUSH RETENTION IS PROVIDED FOR AREAS THAT CURRENTLY DRAIN TO 56TH STREE

6. THE LOWEST FINISH FLOOR ELEVATION OF 1343.83, IS A MINIMUM OF 1' ABOVE THE ADJACENT 100 YEAR WATER SURFACE AND ELEVATION

FINISH FLOOR CERTIFICATION

I HEREBY CERTIFY THAT THE FINISH FLOOR ELEVATION OF 1343.83 IS 1 FOOT ABOVE THE 100 YEAR, 2 HOUR STORM EVENT.

REGISTERED ENGINEER

APPROVAL

THIS SET OF PLANS HAS BEEN REVIEWED FOR COMPLIANCE WITH TOWN OF PARADISE VALLEY REQUIREMENTS PRIOR TO ISSUANCE OF PERMIT. THE TOWN NEITHER ACCEPTS NOR ASSUMES ANY LIABILITY FOR ERRORS OR OMISSIONS. THIS COMPLIANCE APPROVAL SHALL NOT PREVENT THE TOWN ENGINEER FROM REQUIRING CORRECTIONS OF ERRORS OR OMISSIONS IN THE PLANS TO BE FOUND IN VIOLATION OF LAWS OR ORDINANCES.


TOWN OF PARADISE VALLEY

AS-BUILT CERTIFICATION I HEREBY CERTIFY THAT THE "RECORD DRAWING" MEASUREMENTS AS SHOWN HEREON WERE MADE UNDER MY SUPERVISION OR AS NOTED AND ARE CORRECT TO THE BEST OF MY KNOWLEDGE AND BELIEF.

REGISTERED ENGINEER/LAND SURVEYOR

REGISTRATION NO.



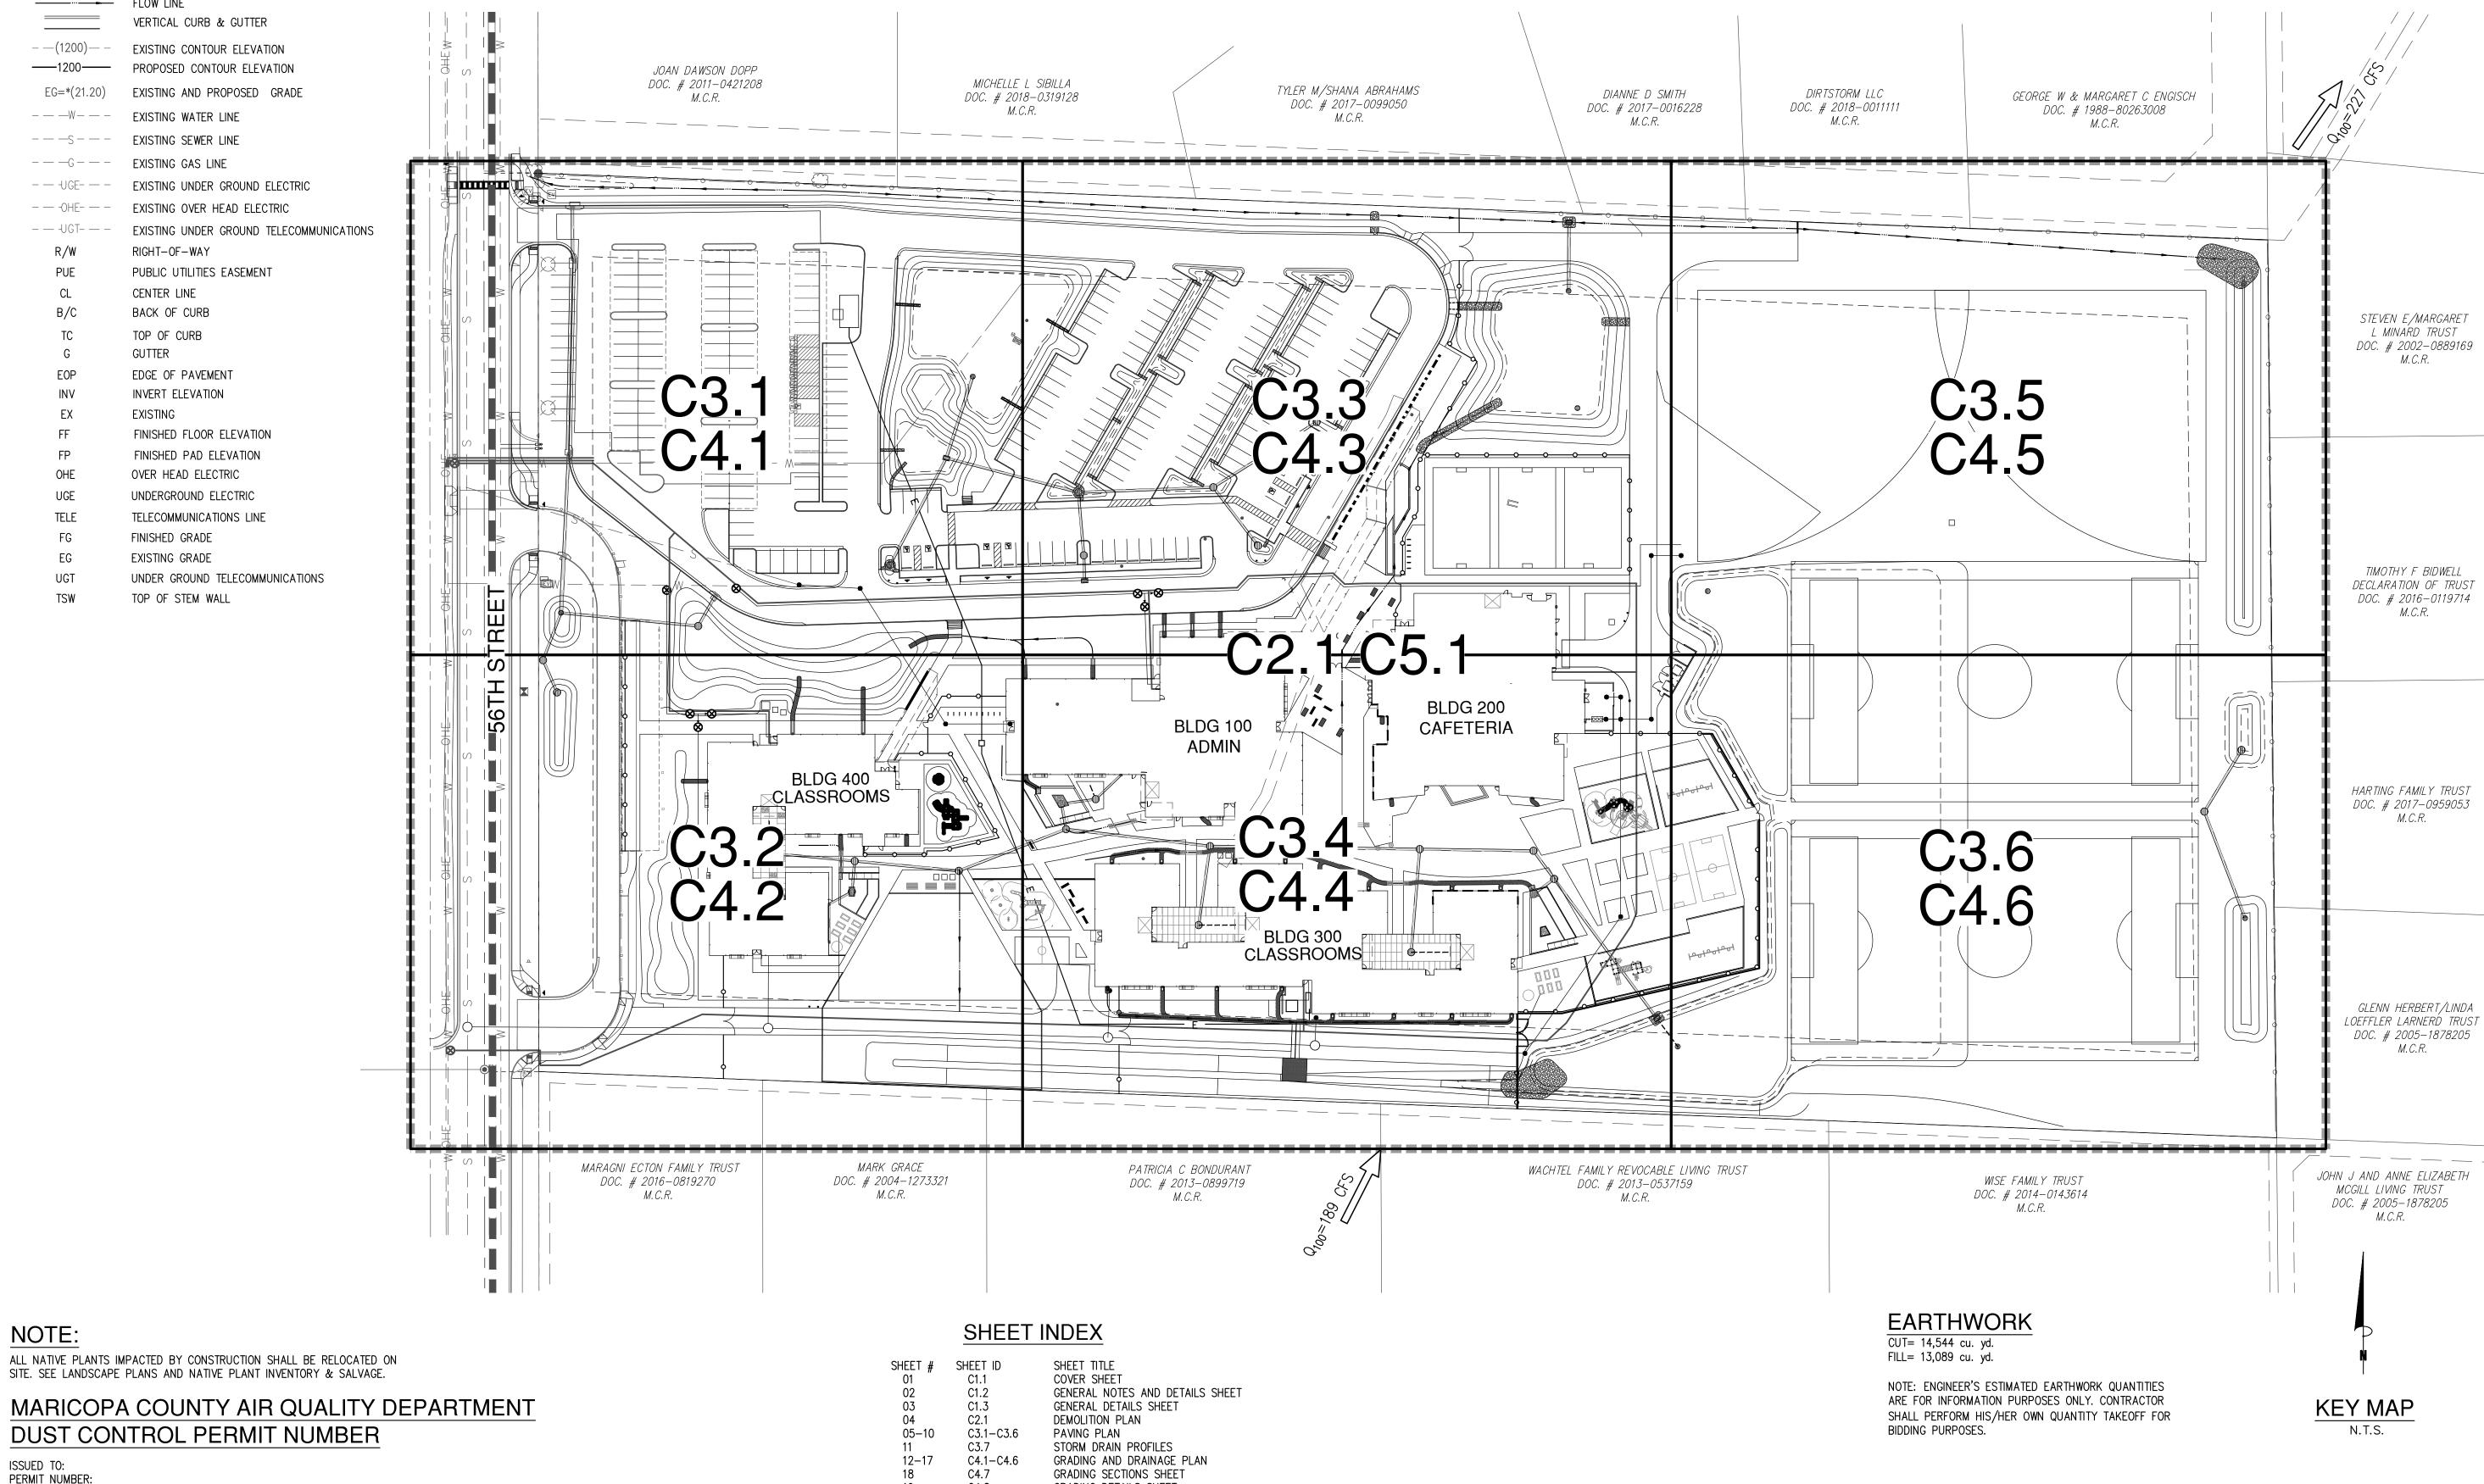

GRADING DETAILS SHEET

SEWER PROFILES SHEET

UTILITY PLAN


CONTRACTOR SHALL COORDINATE

WORK WITHIN RIGHT-OF-WAY

WITH CITY OF PHOENIX 16"

WATER MAIN PROJECT

602.257.9029 f www.owp.com

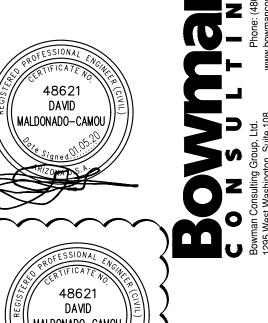

phoenix arizona 85012 oneil.t@owp.com

602.257.1764 t

\ MALDONADO-CAMOU

CLIENT CONTACT Dennis Roehler 9288 E. San Salvador Dr. Scottsdale, AZ 85258 480.484.8503 t

PROJECT NO. DATE OF ISSUE 10.10.19 REVISION NO. 12.10.19 03.25.20 05.15.20 10.09.20

PROJECT TEAM **BOWMAN**

PROJECT PHASE PERMIT SET

SHEET CONTENTS

COVER SHEET

2. THE ESTIMATED QUANTITIES SHOWN ARE FOR INFORMATION PURPOSES ONLY. THE CONTRACTOR SHALL BE RESPONSIBLE FOR THE COMPLETENESS AND ACCURACY OF A DETAILED ESTIMATE BASED ON THESE PLANS, CURRENT CODES, AND SITE

3. ALL EARTHWORK CONSTRUCTION SHALL CONFORM TO THE LATEST MARICOPA ASSOCIATION OF GOVERNMENTS STANDARD DETAILS AND/OR SPECIFICATIONS INCLUDING ANY SUPPLEMENTS THERETO, AND ALL ADDENDA. THE CONTRACTOR IS TO FOLLOW THE RECOMMENDATION OF THE PROJECT SOIL INVESTIGATION REPORT AND LETTER 4. PRIOR TO BIDDING THE WORK, THE CONTRACTOR SHALL THOROUGHLY SATISFY THEMSELVE AS TO THE ACTUAL CONDITIONS

REQUIREMENTS OF THE WORK AND EXCESS OR DEFICIENCY IN QUANTITIES. NO CLAIMS SHALL BE MADE AGAINST THE OWNER/DEVELOPER OR ENGINEER FOR ANY EXCESS OR DEFICIENCY THEREIN. ACTUAL OR RELATIVE. 5. THE ENGINEER SHALL NOT BE RESPONSIBLE FOR CONSTRUCTION MEANS, METHODS, TECHNIQUES, SEQUENCES, PROCEDURES OR SAFETY PRECAUTIONS OR PROGRAMS UTILIZED IN CONNECTION WITH THE WORK, AND WILL NOT BE RESPONSIBLE FOR

THE CONTRACTOR'S FAILURE TO CARRY OUT THE WORK IN ACCORDANCE WITH THE CONTRACT DOCUMENTS

THE ENGINEER SHALL NOT BE RESPONSIBLE FOR COORDINATING THE RELOCATION OF UTILITIES. POWER POLES. ETC. THE CONTRACTOR IS TO VERIFY THE LOCATION, ELEVATION, CONDITION, AND PAVEMENT CROSS-SLOPE OF ALL EXISTING SURFACES AT POINTS OF TIE-IN AND MATCHING, PRIOR TO COMMENCEMENT OF GRADING, PAVING, CURB AND GUTTER OR OTHER SURFACE CONSTRUCTION. SHOULD EXISTING LOCATIONS, ELEVATIONS, CONDITION, OR PAVEMENT CROSS—SLOPE DIFFER FROM THAT SHOWN ON THESE PLANS, RESULTING IN THE DESIGN INTENT REFLECTED ON THE PLANS NOT ABLE TO BE CONSTRUCTED. THE CONTRACTOR SHALL NOTIFY THE OWNER'S AGENT IMMEDIATELY FOR DIRECTION ON HOW TO PROCEED PRIOR TO COMMENCEMENT OF CONSTRUCTION. THE CONTRACTOR ACCEPTS RESPONSIBILITY FOR ALL COSTS

ASSOCIATED WITH CORRECTIVE ACTION IF THESE PROCEDURES ARE NOT FOLLOWED. EXISTING UTILITIES SHOWN ON THESE PLANS HAVE BEEN LOCATED ACCORDING TO INFORMATION PROVIDED BY THE AGENCY OPERATING EACH UTILITY. LOCATIONS SHOWN ARE APPROXIMATE ONLY, AND SHOULD BE CONSIDERED APPROXIMATE CALL ARIZONA BLUE STAKE FOR FIELD LOCATION AT 8-1-1 or 1-800-STAKE-IT A MINIMUM OF TWO (2) WORKING DAYS PRIOR TO EXCAVATION. THE CONTRACTOR SHALL PROTECT AND MAINTAIN ALL EXISTING UTILITIES ON THE SITE NOT NOTED FOR RELOCATION OR REMOVAL. ANY DAMAGE TO EXISTING UTILITIES, WHETHER SHOWN OR NOT ON THE DRAWING, SHALL BE REPAIRED/REPLACED AT THE CONTRACTOR'S EXPENSE. EXISTING SURFACE FEATURES AND FENCING OUTSIDE OF THE

CONSTRUCTION LIMITS SHALL BE REPLACED IN KIND IF DISTURBED. 9. THE ENGINEER AND APPLICABLE AGENCY MUST APPROVE, PRIOR TO CONSTRUCTION, ANY ALTERATION, OR VARIANCE FROM THESE PLANS. ANY VARIATIONS FROM THESE PLANS SHALL BE PROPOSED ON CONSTRUCTION FIELD PRINTS AND

10. ANY INSPECTION BY THE CITY, COUNTY, ENGINEER, OR OTHER JURISDICTIONAL AGENCY, SHALL NOT, IN ANY WAY, RELIEVE THE CONTRACTOR FROM ANY OBLIGATION TO PERFORM THE WORK IN STRICT COMPLIANCE WITH APPLICABLE CODES AND AGENCY REQUIREMENTS. 11. CONTRACTOR IS RESPONSIBLE FOR PROTECTING ALL UNDERGROUND FACILITIES FROM DAMAGE DURING CONSTRUCTION. THE

DEPTH OF COVER IS DESIGNED FOR FINAL GRADE. THEREFORE, EXTRA CARE SUCH AS BERMING OVER PIPES, FLAGGING OR SIGNAGE SHOULD BE USED DURING CONSTRUCTION TO MAINTAIN COVER OR PROTECT THE UNDERGROUND FACILITIES. 12. THE ENGINEER MAKES NO REPRESENTATION OR GUARANTEE REGARDING EARTHWORK QUANTITIES OR THAT THE EARTHWORK FOR THIS PROJECT WILL BALANCE DUE TO THE VARYING FIELD CONDITIONS, CHANGING SOIL TYPES, ALLOWABLE CONSTRUCTION TOLERANCES AND CONSTRUCTION METHODS THAT ARE BEYOND THE CONTROL OF THE ENGINEER. EARTHWORK QUANTITIES SHOWN ARE RAW, AND DO NOT ACCOUNT FOR SOIL SHRINK, SWELL OR GROUND SCARIFICATION. 13. CONTRACTOR SHALL VERIFY HORIZONTAL AND VERTICAL LOCATIONS OF EXISTING PIPE AT PROPOSED CONNECTIONS PRIOR

TO NEW PIPE INSTALLATION. NOTIFY ENGINEER IMMEDIATELY OF CONFLICTS OR DISCREPANCIES FROM THE PLANS. 14. CONTRACTOR TO COMPLY WITH ALL ADA REQUIREMENENTS RELATING TO CONSTRUCTION.

A SEPARATE PERMIT IS NECESSARY FOR ANY OFF-SITE CONSTRUCTION

GENERAL NOTES

A GRADING PERMIT IS REQUIRED UNDER 2015 IRC SEC. 105.1. HAUL PERMITS, WHEN REQUIRED, MUST BE OBTAINED PRIOR TO OR CONCURRENTLY WITH THE GRADING AND DRAINAGE PERMIT

EXCAVATING CONTRACTOR MUST GIVE LOCATION FOR WASTING EXCESS EXCAVATION AND A LETTER FROM OWNER GIVING PERMISSION FOR DUMPING PRIOR TO STARTING ONSITE CONSTRUCTION. IF EXCESS EXCAVATION EXCEEDS 100 CUBIC YARDS, THE DUMPING SITE WILL ALSO REQUIRE A GRADING AND DRAINAGE PERMIT

4. TOWN ENGINEER'S OFFICE SHALL BE NOTIFIED BEFORE ANY ONSITE CONSTRUCTION BEGINS, TELEPHONE (480) 5. CERTIFICATION OF FINISH FLOORS OR BUILDING PADS IS THE RESPONSIBILITY OF THE DEVELOPER AND HIS ENGINEER AND SHALL BE SUBMITTED PRIOR TO A REQUEST FOR CERTIFICATE OF OCCUPANCY OR FINAL INSPECTION.

7. AN APPROVED GRADING AND DRAINAGE PLAN SHALL BE ON THE JOB SITE AT ALL TIMES. DEVIATIONS FROM THE PLANS MUST BE PRECEDED BY AN APPROVED PLAN REVISION. GRADING AND DRAINAGE PLAN APPROVAL INCLUDES THE CONSTRUCTION OF ALL SURFACE IMPROVEMENTS SHOWN ON THE APPROVED GRADING AND DRAINAGE PLAN. INCLUDING, BUT NOT LIMITED TO, RETENTION AREAS AND/OR OTHER DRAINAGE FACILITIES, DRAINAGE PATTERNS, WALLS, CURBS, ASPHALT PAVEMENT AND BUILDING FLOOR

9. CONTRACTOR SHALL PROVIDE LEVEL BOTTOM IN ALL RETENTION BASINS AT ELEVATIONS AS SHOWN ON THE PLANS. RETENTION BASINS SIDE SLOPES SHALL NOT EXCEED 2:1 ON PRIVATE PROPERTY UNLESS NOTED OTHERWISE ON 10. CONTRACTOR IS RESPONSIBLE FOR LOCATING AND CONFIRMING DEPTHS OF ALL THE EXISTING UTILITY LINES WITHIN

CONFLICT WITH UNDERGROUND UTILITIES THE CONTRACTOR SHOULD REQUEST MODIFICATION OF BASIN CONFIGURATION BY SUBMITTAL OF A PROPOSED PLAN REVISION 11. ALL DRAINAGE PROTECTIVE DEVICES SUCH AS SWALES, INTERCEPTOR DITCHES, PIPES, PROTECTIVE BERMS, CONCRETE CHANNELS OR OTHER MEASURES DESIGNED TO PROTECT BUILDINGS OR PROPERTY FROM STORM RUNOFF

PROPOSED RETENTION BASIN AREAS. IF THE BASIN CANNOT BE CONSTRUCTED AS PER PLAN BECAUSE OF

MUST BE COMPLETED PRIOR TO ANY STRUCTURE BEING BUILT 12. SOILS COMPACTION TEST RESULTS MUST BE SUBMITTED TO THE TOWN ENGINEER'S OFFICE FOR BUILDING PADS THAT HAVE A ONE FOOT OR MORE OF FILL MATERIAL INDICATED. THIS INFORMATION MUST BE SUPPLIED PRIOR TO REQUEST FOR FINAL INSPECTION.

13. THE DESIGN ENGINEER SHALL INDICATE ALL KNOWN EXISTING UNDERGROUND UTILITIES WITHIN PROPOSED RETENTION AREAS. THE BASIN SHOULD BE DESIGNED TO MAINTAIN A MINIMUM 15" OF COVER UTILITY LINES. 14. CLEARANCE FOR OCCUPATION OF ANY BUILDING IS DENIED UNTIL GRADING AND DRAINAGE IMPROVEMENTS ARE

15. APPROVAL OF THESE PLANS SHALL NOT PREVENT THE TOWN FROM REQUIRING CORRECTION OF ERRORS, IN THE PLANS WHERE SUCH ERRORS ARE SUBSEQUENTLY FOUND TO BE IN VIOLATION OF ANY LAW OR ORDINANCE 16. SCARRED ROCK SURFACES (CUT AND FILL) ARE TO BE TREATED WITH CHEMICAL COLOR TREATMENT TO BLEND WITH THE NATIVE ROCK SURFACES.

17. NO CERTIFICATE OF OCCUPANCY SHALL BE ISSUED UNTIL ALL HILLSIDE STIPULATIONS AND ALL TOWN CODE REQUIREMENTS ARE COMPLIED WITH INCLUDING, BUT NOT LIMITED TO LANDSCAPING, FIRE FLOW, FIRE SAFETY AND ALL ONSITE AND OFF-SITE IMPROVEMENTS.

18. ALL OUTDOOR LIGHTING SHALL BE IN CONFORMANCE WITH SECTION 2208 OF THE TOWN CODE. 19. ALL EXCESS FILL MATERIAL SHALL BE REMOVED FROM THE SITE WITH NO NEW SPILL SLOPES. 20. THE USE OF HYDRAULIC RAM HAMMERS OR OTHER HEAVY EQUIPMENT USED TO CUT THROUGH ROCK, INCLUDING

MACHINERY WITH AUDIBLE BACK UP WARNING DEVICES SHALL BE LIMITED TO USE BETWEEN THE HOURS OF 7:00AM OR SUNRISE, WHICHEVER IS LATER, AND 6:00PM OR SUNSET, WHICHEVER IS EARLIER, MONDAY THROUGH FRIDAY WITH LIMITED WORK ON SATURDAY AND NO WORK ON SUNDAY OR LEGAL HOLIDAYS. RAM HAMMERS AND OTHER HEAVY EQUIPMENT CANNOT BE USED ON SATURDAYS WITHOUT A WAIVER FROM THE TOWN MANAGER.

21. CONSTRUCTION STAKING AND/OR FENCING SHALL BE PLACED AROUND THE CONSTRUCTION SITE SO AS TO PROTECT THE UNDISTURBED NATURAL AREAS.

NOTES

GRADING TO BE CONFORMANCE WITH THE 2015 IBC. PRIOR TO THE FIRST FOOTING INSPECTION OF ANY TYPE, ALL PROPERTY PINS SHALL BE PLACED BY A REGISTERED LAND SURVEYOR OF THE STATE OF ARIZONA, AND PROPERTY LINES MUST BE PHYSICALLY IDENTIFIED THIS PLAN IS DESIGNED TO SHOW SITE GRADING AND DRAINAGE. CONTRACTOR SHALL USE THE ARCHITECTURAL

SITE PLAN FOR FINAL HOUSE, WALL STEP, ETC. DIMENSIONS AND LOCATIONS. 4. WHERE ON SITE LOT GRADING OCCURS: THE TOP OF 4" OF EXCAVATED NATIVE SOIL SHALL REMAIN ON SITE AND SHALL BE REUSED AS A NATURAL SOIL SEED BANK FOR ON SITE FINISH GRADING AND SUPPLEMENTAL SEEDING

5. A DUST CONTROL PLAN MEETING THE REQUIREMENTS OF RULE 310 OF THE MARICOPA COUNTY AIR POLLUTION CONTROL REGULATIONS, AS AMENDED, IS REQUIRED. 6. ALL EXTERIOR SITE LIGHTING SHALL COMPLY WITH THE TOWN OF PARADISE VALLEY ZONING ORDINANCE NO. 1023 FOR FUTURE TYPE, LOCATION, HEIGHT, WATTAGE BASED UPON FIXTURES INSTALLED.

CONTRACTOR SHALL FIELD VERIFY ALL EXISTING UTILITIES AND FEATURES PRIOR TO CONSTRUCTION FOR CONFLICT PURPOSES AND COORDINATE WITH ARCHITECT FOR POTENTIAL CONFLICT RESOLUTION. 8. 5% MINIMUM SLOPE AWAY FROM BUILDING FOR A MINIMUM OF 10' UNLESS NOTED OTHERWISE.

GRADING SPECIFICATIONS

1. EXCAVATION AND GRADING OF THIS SITE IS CLASSIFIED AS "ENGINEERED GRADING" PER 2015 IBC AND WILL BE PERFORMED ACCORDINGLY. 2. THE DEVELOPER WILL RETAIN A SOILS ENGINEER DURING CONSTRUCTION TO INSPECT PROGRESS OF

STABILITY OF ALL FINISH SLOPES INCLUDING CUT SLOPES BEARING MATERIALS FOR FILL UNDER RESIDENCE PAD IF NATIVE MATERIAL IS USED. LARGE ROCK FRAGMENTS MUST BE REMOVED THAT ARE IN EXCESS OF SIX INCHES. REMAINING MATERIAL MUST BE SMALLER PARTICLES OF SAND ROCK THAT CAN BE COMPACTED INTO A DENSE CONDITION.

CONSTRUCTION. CONCERNING PREPARATION OF GROUND TO RECEIVE FILLS, TESTING AND REQUIRED COMPACTION

MAXIMUM PARTICLE SIZE PERCENT PASSING NO. 4 SIEVE PERCENT PASSING NO. 200 SIEVE PLASTICITY INDEX

6 INCHES 35% TO 70% 25% MAX 10% MAX

4. CUT-SLOPES: MAXIMUM CUT SLOPES TO BE 1.0 FOOT HORIZONTAL TO 2.5 FEET VERTICAL 5. FILL-SLOPES: MAXIMUM FILL SLOPES TO BE 2 FEET HORIZONTAL TO 1 FOOT VERTICAL.

6. COMPACTION FILL MATERIAL MUST BE PLACED ON LEVELED BENCHES CUT INTO UNDISTURBED EXISTING HILLSIDE. PLACE FILL IN HORIZONTAL LIFTS OF THICKNESS COMPATIBLE WITH THE COMPACTION EQUIPMENT USED. COMPACT TO A MINIMUM OF 95% OF THE MAXIMUM A.S.T.M. DENSITY AT THE OPTIMUM MOISTURE CONTENT OF \pm TWO PERCENT. THIS PERTAINS TO ALL ENGINEERED STRUCTURAL FILL SUPPORTING STRUCTURES AND INCLUDING FILL UNDER ANY OF THE RETAINING WALLS. COMPACTION TEST RESULTS SHALL BE SUBMITTED TO THE SOILS ENGINEER AND TOWN OF PARADISE VALLEY BUILDING AND SAFETY DEPARTMENT

AND RETAINING WALLS ADJACENT TO THE PROPERTY LINES WILL BE UNDER THE SCOPE OF SPECIAL INSPECTION BY THE SOILS ENGINEER. THE DEVELOPER SHALL NOTIFY THE ADJOINING PROPERTY OWNERS IN WRITING, TEN DAYS PRIOR TO START OF CONSTRUCTION ON THESE WALLS PER SECTION 2903-B OF I.B.C. THE DEVELOPER WILL HAVE TO PROVIDE MEANS OF PROTECTION OF ADJACENT PROPERTY WHILE THIS WORK IS UNDER CONSTRUCTION.

8. ALL EXPOSED CUT AND FILL SHALL BE TREATED WITH AN APPROVED AGING AGENT TO MINIMIZE TO VISUAL CONTINUITY.

9. NO CERTIFICATE OF OCCUPANCY SHALL BE ISSUED UNTIL ALL HILLSIDE STIPULATIONS AND ALL TOWN CODE REQUIREMENTS ARE COMPLIED WITH INCLUDING, BUT NOT LIMITED TO LANDSCAPING, FIRE FLOW, FIRE SAFETY AND ALL ONSITE AND OFF-SITE IMPROVEMENTS.

10. ALL OUTDOOR LIGHTING SHALL BE IN CONFORMANCE WITH SECTION 1023 OF THE TOWN CODE. 11. ALL EXCESS FILL MATERIAL SHALL BE REMOVED FROM THE SITE WITH NO NEW SPILL SLOPES. 12. THE USE OF HYDRAULIC HAMMERS AND HEAVY EQUIPMENT SHALL BE LIMITED TO USE BETWEEN THE HOURS OF 7:00 AM AND 6:00 PM MONDAY THROUGH SATURDAY WITH NO WORK ON SUNDAY.

13. CONSTRUCTION STAKING AND/OF FENCING SHALL BE PLACED AROUND THE CONSTRUCTION SITE SO AS TO PROTECT THE UNDISTURBED NATURAL AREAS.

PARADISE VALLEY GENERAL NOTES

PRIOR TO THE FIRST INSPECTION OF STRUCTURES WITHIN 3 FEET OF A SETBACK LINE, THE PROPERTY PINS SHALL BE PLACED BY A REGISTERED CIVIL ENGINEER OR LAND SURVEYOR OF THE STATE OF ARIZONA, AND THE PROPERTY LINE(S) IDENTIFIED.

WHERE EXCAVATION IS TO OCCUR THE TOP 4" OF EXCAVATED NATIVE SOIL SHALL REMAIN ON THE SITE AND SHALL BE REUSED IN A MANNER THAT TAKES ADVANTAGE OF THE NATURAL SOIL SEED BANK IT CONTAINS. ALL WORK REQUIRED TO COMPLETE THE CONSTRUCTION COVERED BY THIS PLAN SHALL BE IN ACCORDANCE WITH THE MARICOPA ASSOCIATION OF GOVERNMENTS (M.A.G.) STANDARD SPECIFICATIONS AND DETAILS AND CURRENT SUPPLEMENTS THEREOF PER THE LOCAL MUNICIPALITY UNLESS SPECIFIED OTHERWISE IN THESE PLANS OR ELSEWHERE IN THE CONTRACT DOCUMENTS.

4. THE CONTRACTOR IS TO COMPLY WITH ALL LOCAL STATE, AND FEDERAL LAWS AND REGULATIONS APPLICABLE TO THE CONSTRUCTION COVERED BY THIS PLAN. THE CONTRACTOR IS RESPONSIBLE FOR OBTAINING AND COMPLYING WITH ALL PERMITS REQUIRED TO COMPLETE ALL WORK COVERED BY THIS PLAN. ALL EXTERIOR SITE LIGHTING SHALL COMPLY WITH THE APPLICABLE REQUIREMENTS FOR TYPE, LOCATION, HEIGHT.

WATTAGE. AND LUMEN BASED UPON THE FIXTURES INSTALLED PURSUANT TO SECTION 1023 OF THE TOWN OF PARADISE VALLEY ZONING ORDINANCE FOR NON-HILLSIDE PROPERTIES, SECTION 2208 OF THE TOWN OF PARADISE VALLEY ZONING ORDINANCE FOR HILLSIDE PROPERTIES, OR AS SPECIFIED IN THE SPECIAL USE PERMIT FOR SPECIAL

USE PERMIT PROPERTIES. A DUST CONTROL PLAN AND PERMIT MEETING THE REQUIREMENTS OF RULE 310 OF THE MARICOPA COUNTY AIR POLLUTION CONTROL REGULATIONS, AS AMENDED, IS REQUIRED. A SEPARATE RIGHT-OF-WAY PERMIT IS NECESSARY FOR ANY OFF-SITE CONSTRUCTION. AN APPROVED GRADING AND DRAINAGE PLAN SHALL BE ON THE JOB SITE AT ALL TIMES. DEVIATIONS FROM THE

PLAN MUST BE PRECEDED BY AN APPROVED PLAN REVISION. 10. EAVE PROJECTIONS INTO REQUIRED SETBACKS ARE LIMITED TO A MAXIMUM OF 24" PURSUANT TO SECTION 1008 OF THE TOWN OF PARADISE VALLEY ZONING ORDINANCES. 11. ALL STRUCTURES AND LANDSCAPING WITHIN THE SIGHT VISIBILITY TRIANGLE SHALL HAVE A 2 FOOT MAXIMUM HEIGHT . ALL NEW AND EXISTING ELECTRICAL SERVICE LINES SHALL BE BURIED PER THE TOWN OF PARADISE VALLEY

REQUIREMENTS. 3. IT SHALL BE THE RESPONSIBILITY OF THE PERMITIEE TO ARRANGE FOR THE RELOCATION AND RELOCATION COSTS OF ALL UTILITIES. AND TO SUBMIT A UTILITY RELOCATION SCHEDULE PRIOR TO THE ISSUANCE OF AN ENGINEERING CONSTRUCTION PERMIT

14. EXISTING AND/OR NEW UTILITY CABINETS AND PEDESTALS SHALL BE LOCATED A MINIMUM OF 4' BEHIND ULTIMATE BACK OF CURB LOCATION. 15. POOL, SPA, BARBECUE AND ANY PROPOSED STRUCTURES OVER 8" ABOVE GRADE REQUIRE SEPARATE PERMIT APPLICATIONS.

16. POOLS SHALL BE CONSTRUCTED BY SEPARATE PERMIT AND SECURED FROM UNWANTED ACCESS PER TOWN CODE ARTICLE 5-2. 17. ALL FILL MATERIAL UNDER SLABS AND WALKS SHALL BE COMPACTED TO NOT LESS THAN 95%. 18. SETBACK CERTIFICATION IS REQUIRED AND SHALL BE PROVIDED TO TOWN INSPECTOR PRIOR TO STEM WALL

INSPECTION. 19. FOR BUILDING PADS THAT HAVE 1' OR MORE OF FILL MATERIAL SOILS COMPACTION TEST RESULTS ARE REQUIRED AND SHALL BE PROVIDED TO TOWN INSPECTOR PRIOR TO PRE-SLAB INSPECTION. 20. FINISHED FLOOR ELEVATION CERTIFICATION IS REQUIRED AND SHALL BE PROVIDED TO TOWN INSPECTOR PRIOR TO

FRAMING INSPECTION. 21. MAIL BOXES SHALL COMPLY WITH THE TOWN OF PARADISE VALLEY STANDARDS FOR MAIL BOXES IN THE RIGHT-OF-WAY FOR HEIGHT, WIDTH AND BREAK AWAY FEATURES.

22. ALL PATIOS, WALKS, AND DRIVES TO SLOPE AWAY FROM BUILDING AND GARAGES AT A MINIMUM SLOPE OF 1/4" PER FOOT UNLESS SPECIFIED OTHERWISE 23. TRENCH BEDDING AND SHADING SHALL BE FREE OF ROCKS AND DEBRIS.

24. THE TOWN ONLY APPROVES THE SCOPE OF WORK AND NOT THE ENGINEERING DESIGN. ANY CONSTRUCTION QUANTITIES SHOWN ARE NOT VERIFIED BY THE TOWN. 25. THE APPROVAL OF THE PLANS IS VALID FOR 180 DAYS. IF A PERMIT FOR CONSTRUCTION HAS NOT BEEN ISSUED WITHIN 180 DAYS, THE PERMIT MUST BE RENEWED 26. A TOWN INSPECTOR WILL INSPECT ALL WORK WITHIN THE TOWN'S RIGHTS-OF-WAY. NOTIFY TOWN INSPECTION

SERVICES TO SCHEDULE A PRECONSTRUCTION MEETING PRIOR TO STARTING CONSTRUCTION 27. WHENEVER EXCAVATION IS NECESSARY, CALL ARIZONA811 BY DIALING 811 or 602:263-1100, TWO (2) WORKING DAYS BEFORE EXCAVATON BEGINS. 28. EXCAVATIONS SHALL COMPLY WITH REQUIREMENTS OF OSHA EXCAVATION STANDARDS \{29 CFR, PART 1926, SUBPART

P). UNDER NO CIRCUMSTANCES WILL THE CONTRACTORS BE ALLOWED TO WORK IN A TRENCH LOCATED WITHIN THE TOWN'S RIGHT-OF-WAY WITHOUT PROPER SHORING OR EXCAVATION METHODS 29. PERMIT HOLDER SHALL POST A 6 SQUARE FOOT (2'X3') IDENTIFICATION SIGN, MADE OF DURABLE MATERIAL, IN THI FRONT YARD OF SUBJECT PROPERTY AND NOT IN THE TOWN'S RIGHT-OF-WAY. THE SIGN MAY NOT EXCEED A

MAXIMUM OF 6 FEET IN HEIGHT FROM GRADE TO TOP OF THE SIGN. THE SIGN MUST INCLUDE THE PERMITIEE OR COMPANY NAME, PHONE NUMBER. TYPE OF WORK, ADDRESS OF PROJECT AND TOWN CONTACT NUMBER, 480-348-3556 30. WHEN DEEMED NECESSARY, A 6-FOOT HIGH CHAIN LINK FENCE MUST BE INSTALLED AROUND THE CONSTRUCTION

AREA TO PREVENT ANY POTENTIAL SAFETY HAZARD FOR THE PUBLIC. THE FENCE SHALL BE SET BACK AT LEAST 10 FEET FROM ALL RIGHTS-OF-WAY AND HAVE A 50-FOOT STREET CORNER SITE TRIANGLE WHERE APPLICABLE 31. CLEAR ACCESS FOR NEIGHBORING PROPERTIES AND EMERGENCY VEHICLES MUST BE MAINTAINED AT ALL TIMES. CONSTRUCTION RELATED VEHICLES MUST BE LEGALLY PARKED ONLY ON ONE SIDE OF THE STREET OR JOB SITE

(12a) ADJUST MANHOLE FRAME AND COVER

12b) ADJUST MANHOLE FRAME AND COVER

SHALL BE BLACK CONCRETE.

13) ADJUST WATER VALVE FRAME AND

COVER PER MAG STD DTL 270

13a) ADJUST WATER VALVE FRAME AND

14) INSTALL 6" CONCRETE PAVEMENT

17) INSTALL 25' COMMERCIAL DRIVEWAY

PER MAG STD DTL 131 TYPE B

20) UNDERGROUND ELECTRICAL SLEEVE,

21) UNDERGROUND ELECTRICAL RISER, SEE

ELECTRICAL PLANS FOR MORE INFO

22) INSTALL SAFETY FENCE, SEE ARCHITECTURAL

GUTTER PER PLANS

SINGLE CURB

VERTICAL CURB

MATCH BASIN OR

CHANNEL SLOPE

PER PLANS

-PER MAG STD DTL

222 TYPE A

PER PLANS

VERTICAL

PLANS

CURB PER-

SINGLE CURB TO ROLL CURB

TRANSITION DETAIL

N.T.S.

SEE ELECTRICAL PLANS FOR

18) INSTALL R1-1 30"x30" STOP SIGN PER

MUTCD STDS, SIGN POST AND BASE

19) INSTALL 4" FIRE HYDRANT PROTECTION

BOLLARD PER MAG STD DTL 140 TYPE 1

PER SECTION#3 ON SHT C1.2

PER MAG STD DTL 250-2

AND DTL ON SHT C1.3

PLANS FOR MORE INFO

18" WIDE RIBBON CURB

PER MAG STD DTL

CURB & GUTTER TO RIBBON CURB

TRANSITION DETAII

18" WIDE RIBBON CURB

SINGLE TO RIBBON CURB

TRANSITION DETAII

PLANS

220-1 TYPE B (MOD)

←PER MAG STD DTL

(MODIFIED WIDTH

PER MAG STD DTL 422, CONCRETE COLLAR

COVER PER MAG STD DTL 270, CONCRETE

COLLAR SHALL BE BLACK CONCRETE

PER MAG STD DTL 422

32. ALL CONSTRUCTION DEBRIS AND EQUIPMENT MUST BE CONTAINED ON SITE AT ALL TIMES. CONTRACTOR AND PROPERTY OWNER MUST MAINTAIN THE JOB SITE FREE OF LITTER AND UNSIGHTLY MATERIALS AT ALL TIMES. CONSTRUCTION MATERIALS ARE PROHIBITED IN THE TOWN'S RIGHT-OF-WAY. 33. CONSTRUCTION ACTIVITIES ARE PERMITIED BETWEEN THE HOURS OF 7 AM AND 5 PM MONDAY THROUGH FRIDAY.

CONSTRUCTION ACTIVITIES MAY START ONE (1) HOUR EARLIER DURING THE SUMMER (MAY 1ST THROUGH SEPTEMBER 34. THE USE AND OPERATION OF FUEL-FIRED GENERAIORS IS PROHIBITED UNLESS DUE TO A HARDSHIP. TOWN APPROVAL

SHALL BE REQUIRED. 35. THE CONTRACTOR AND PROPERTY OWNER SHALL BE LIABLE FOR ANY DAMAGE DONE TO ANY PUBLIC PROPERTY AS A RESULT OF ANY CONSTRUCTION OR CONSTRUCTION RELATED ACTIVITIES. NO CERTIFICATE OF OCCUPANCY WILL BE ISSUED UNTIL ALL AFFECTED RIGHTS-OF-WAY ARE CLEANED AND/OR REPAIRED TO THEIR ORIGINALCONDITION AND UNTIL ANY AND ALL DAMAGES TO AFFECTED PROPERTIES ARE RESTORED TO ORIGINAL CONDITION. 36. A KEYED SWITCH SHALL BE REQUIRED ON ALL NEW AND EXISTING ELECTRIC ENTRY GATES. THE KEYED SWITCH SHALL BE INSTALLED IN A LOCATION THAT IS READILY VISIBLE AND ACCESSIBLE. KNOX BOX ORDER FORMS ARE AVAILABLE

AT THE TOWN'S BUILDING SAFETY DEPARTMENT. 37. PROPERTY OWNER, BUILDER, OR GENERAL CONTRACTOR WILL BE RESPONSIBLE FOR CONTROLLING DUST FROM THE SITE AT ALL TIMES. ALL MEANS NECESSARY SHALL BE USED BY THE BUILDER OR GENERAL CONTRACTOR TO CONTROL THE EXISTENCE OF DUST CAUSED BY ANY EARTHWORK. SPRAY APPLICATION OF MATERIALS. OR OTHER

DUST-CAUSING PRACTICES REQUIRED BY THE CONSTRUCTION PROCESS. 38. APPROVAL OF THESE PLANS ARE FOR PERMIT PURPOSES ONLY AND SHALL NOT PREVENT THE TOWN FROM REQUIRING CORRECTION OF ERRORS IN THE PLANS WHERE SUCH ERRORS ARE SUBSEQUENTLY FOUND TO BE IN

VIOLATION OF ANY LAW, ORDINANCE, HEALTH, SAFETY, OR OTHER DESIGN ISSUES 39. ALL DRAINAGE PROTECTIVE DEVICES SUCH AS SWALES, INTERCEPTION DITCHES, PIPES PROTECTIVE BERMS, CONCRETI CHANNELS OR OTHER MEASURES DESIGNED TO PROTECT PROPOSED AND EXISTING IMPROVEMENTS FROM RUNOFF OR DAMAGE FROM STORM WATER, MUST BE CONSTRUCTED PRIOR TO THE CONSTRUCTION OF ANY IMPROVEMENTS.

6" NON-REINFORCED

CLASS "B" CONCRETE

PER MAG SPEC 340

CURB OPENING

SIZE PER PLAN

SECTION "A

CURB OPENING & SPILLWAY

PER PLANS

FL=PER PLAN

-CURB PER

PLANS

CURB PER-

PLANS

GROUTED RIP-RAP

D50=6", 12" THICK

COLOR & TYPE-

PLANS.

PER LANDSCAPE

VERTICAL CURB

PER PLANS

VERTICAL

-CURB PER

PLANS

-CURB PER

VERTICAL CURB

PER PLANS

GROUTED RIP-RAP

D50=6", 12" THICK

COLOR & TYPE-

PLANS

BOTTOM OF BASIN-

CURB OPENING AND RIP-RAP SPILLWAY DETAIL

PER LANDSCAPE

PLANS

PAVING CONSTRUCTION NOTES WATER CONSTRUCTION NOTES) INSTALL 3" AC OVER 6"ABC PER 3881 SY INSTALL 6" DIP WATER LINE SERVICE ASPHALTIC PAVEMENT SECTION#1 WITH TRACER WIRE PER MAG SPEC 610 ON SHT C1.2 AND PLUMBING CODE) INSTALL 2"AC OVER 6" ABC PER 6054 SY INSTALL 3" DIP WATER LINE SERVICE ASPHALTIC PAVEMENT SECTION#2 ⊣ WITH TRACER WIRE PER MAG SPEC 610 ON SHT C1.2 AND PLUMBING CODE) INSTALL 3' VALLEY GUTTER PER 190 SF 2a INSTALL 2.5" PVC WATER LINE MAG STD DTL 240 ┘ SERVICE WITH TRACER WIRE PER MAG SPEC 610 AND PLUMBING CODE 4) INSTALL 18" WIDE RIBBON CURB PER MAG STD DTL 220-1, TYPE B (MODIFIED WIDTH) 2b | INSTALL 2" PVC WATER LINE ── SERVICE WITH TRACER WIRE PER (4a) INSTALL 4" ROLL CURB AND GUTTER 257 LF ____MAG_SPEC_610_AND_PLUMBING_CODE______ igcup PER MAG STD DTL 220-1, TYPE C2c | INSTALL 3/4" PVC WATER LINE) INSTALL SINGLE CURB TO RIBBON CURB ─ SERVICE WITH TRACER WIRE PER TRANSITION PER DTL ON SHT C1.2 MAG SPEC 610 AND PLUMBING CODE (5a) INSTALL VERTICAL CURB AND GUTTER | EXISTING 6" WATER METER O RIBBON CURB TRANSITION PER O BE PROTECTED IN PLACE DTL ON SHT C1.2 4 | CUT INTO EXISTING 6" WATER LINE (5b) INSTALL VERTICAL CURB AND GUTTER → AND INSTALL 6" DOUBLE CHECK VALVE SINGLE CURB TRANSITION PER BACKFLOW PREVENTER ASSEMBLY DTL ON SHT C1.2 PER COP STD DTL P1352 $(\, \mathsf{5c}\,)$ INSTALL SINGLE CURB TO ROLL CURB 3 EA LI CUT INTO EXISTING 6" WATER LINE TRANSITION PER DTL ON SHT C1.2 → AND INSTALL 6"X6" TEE 6) INSTALL 6" SINGLE CURB PER 2167 LF 6 | Install 6"x3" tee ✓ MAG STD DTL 222, TYPE A \sim (6a) INSTALL 6" VERTICAL CURB AND GUTTER 6a | INSTALL 3" TEE WITH 3"X1" REDUCER PER MAG STD DTL 220-1, TYPE A) INSTALL 6' VALLEY GUTTER AND APRON INSTALL 6"X3" REDUCER 2 EA PER MAG STD-DT-240 (7a)INSTALL 6'VALLEY GUTTER PER DTL 7a | INSTALL 3"X2.5" REDUCER NSHI CI3) INSTALL CONCRETE SIDEWALK PER 8 | INSTALL 90° BEND, SIZE PER PLAN MAG STD DTL 230 (WIDTH PER PLANS) SEE LANDSCAPE PLÀNS FOR ADDITIONAL INFORMATION INSTALL 45° BEND, SIZE PER PLAN (8a) HARDSCAPE, SEE ARCHITECTURAL (73649 SF PLANS FOR FINISH AND ADDITIONAL O I INSTALL 6" VALVE BOX AND COVER PER INFORMATION J MAG SPEC SEC 630, MAG STD DTL 391−1 TYPE C WITH CONCRETE COLLAR AND (8b) INSTALL GRASSPAVE2 FIRE LANE 3509 SF PLUMBING CODE PER SECTION#3 ON SHT C1.2 INSTALL 3" VALVE BOX AND COVER '8c) INSTALL DG FIRE LANE PFR 7381 SF → PER MAG SPEC SEC 630, STD DTL 391-1 SECTION#4 ON SHT C1.2 TYPE C WITH CONCRETE COLLAR (8d) INSTALL CONCRETE SIDEWALK PER 1864 SF AND PLUMBING CODE ' MAG STD DTL 230 (WIDTH PER PLANS) 1a NSTALL 2.5" VALVE BOX AND COVER COLOR SHALL BE SAN DIEGO BUFF $^{ ightharpoonup}$ PER MAG SPEC SEC 630. STD DTL 391 $^{-1}$ OR APPROVED EQUAL TYPE C WITH CONCRETE COLLAR 9) INSTALL SIDEWALK RAMP PER 2 EA AND PLUMBING CODE MAG STD DTL 237-3 2 I INSTALL WATER CAP FOR BUILDING CONNECTION (9a) INSTALL SIDEWALK RAMP PER SEE PLUMBING PLANS FOR CONTINUATION 2a INSTALL WATER SERVICE FOR (9b) INSTALL SIDEWALK RAMP PER ┘ LANDSCAPE PLANTER BEDS. MAK STUDIL 238-2 MAK ST REFER TO LANDSCAPE PLANS FOR VALVES AND RACKFLOW (10) INSTALL ACCESSIBLE PARKING STALL WITH WHEEL STOP. SIGNS AND STRIPING 22 | INSTALL 2" LANDSCAPE WATER METER. PER DTL ON SHT C1.3, PARKING NOT $^{ t J}$ BOX AND COVER PER COP STD DTLS TO EXCEED 2% SLOPE IN ANY DIRECTION P1315, P1342, P1363 AND WATR SERVICE DEPARTMENT REQUIREMENTS (10a) INSTALL CONCRETE WHEEL STOP PER DTL ON SHT C1.3 23 | INSTALL 2" DOUBLE CHECK VALVE BACK FLOW → PREVENTER ASSEMBLY PER COP STD DTL P1352 11) INSTALL 4" WIDE PAINT STRIP 23 EA (12) ADJUST CLEANOUT FRAME AND 15 EA 3" AC ASPHALTIC PAVEMENT COVER PER MAG STD DTL 270

3 EA

1 EA

21 EA

1 EA

2 EA

2 EA

10 EA

722 LF

∕15**\ (** 6 EA

SINGLE TO CURB AND

GUTTER TRANSITION DETAIL

N.T.S.

PER PLANS' 6"

SECTION A-A

N.T.S.

GROUTED RIP-RAP

D50=6", 12" THICK

LANDSCAPE PLANS

COLOR & TYPE PER

1 EA

UTTER PER PLANS

CURB & GUTTER

←PER MAG STD DTL

220-1, TYPE A

5790 SF


12" PREPARED SUBGRADE PER -MAG SPEC 301 AND SOILS **ASPHALTIC PAVEMENT** SECTION #1 BUS LANES, TRUCK DRIVES AND FIRE LANES NOTF: REFER TO GEOTECHNICAL REPORT BY "RICKEY.ATKISON.MCBEE.NORMAN & ASSOCIATES, INC." FOR DETAILED PAVEMENT RECOMMENDATIONS 2" AC ASPHALTIC PAVEMENT PER MAG SPEC 321

PER MAG SPEC 32


" ABC PER MAG


SPEC 310 & 702

& 720, (1/2"MIX)

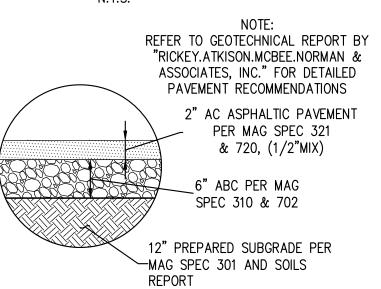


ASPHALTIC PAVEMENT SECTION #2

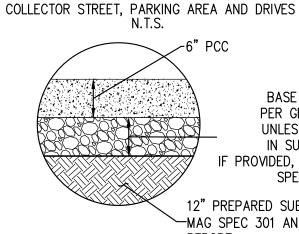

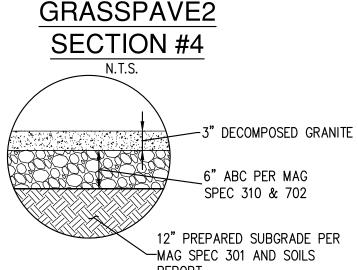

DECOMPOSED GRANITE SECTION#5

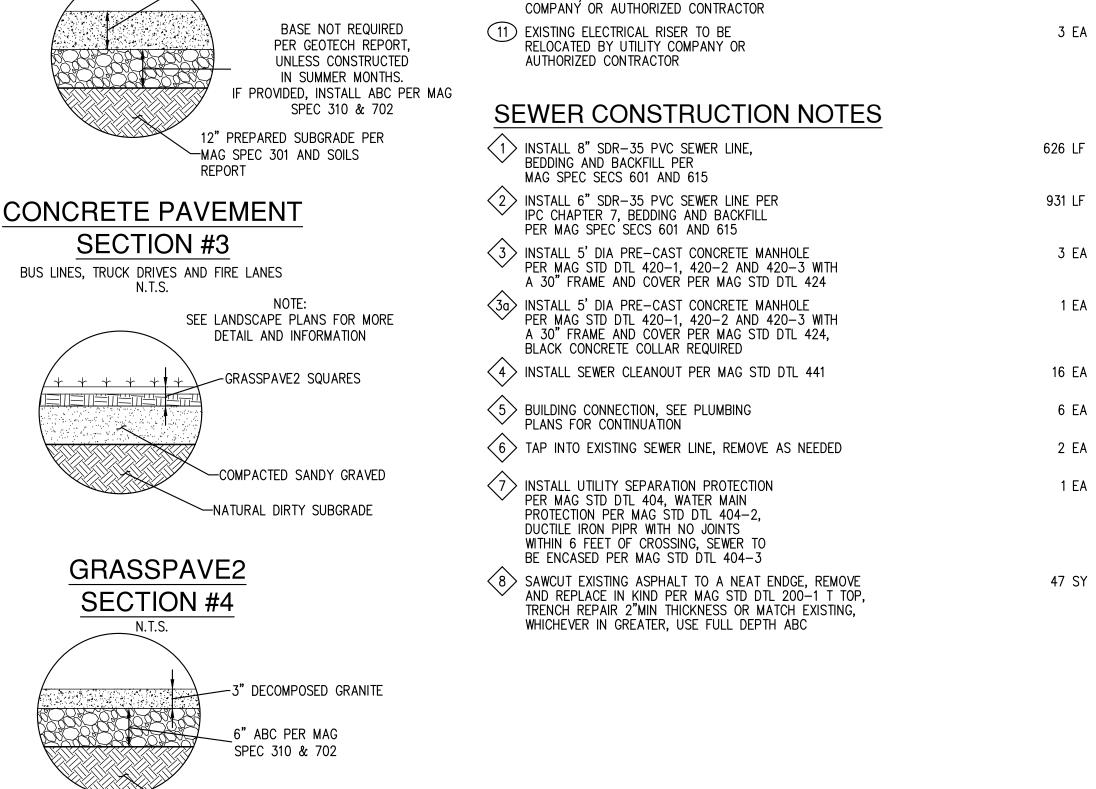

ESTIMATED CONSTRUCTION QUANTITIES ARE NOT FOR BIDDING PURPOSES. CONTRACTOR SHALL BASE THEIR BID ON THEIR OWN QUANTITY TAKEOFFS



8 EA

5 EA

3 EA

1 EA

1 EA

15 EA

2 EA

8 EA

1 EA

751 SF

1559 LF

414 LF

2 EA

82 LF

3 EA

343 SF

103 LF

5 EA

8 EA

313 LF

26 LF

11 EA

1 EA

1 EA

16 EA

177052 SF

7185 SY

3230 LF

6923 LF

3718 LF

13 EA

2 EA

12 EA

529 LF

12 EA

1 EA

all at least two full working da

Arizona Blue Stake, Inc.

Dial 8-1-1 or 1-800-STAKE-IT (782-5 n Maricopa County: (602) 263-11

STORM DRAIN CONSTRUCTION NOTES

1 > INSTALL MAXWELL IV DRYWELL

2 > INSTALL STORM DRAIN CATCH BASIN

3) INSTALL STORM DRAIN CATCH BASIN

(3a) INSTALL GROUTED RIP-RAP APRON

3b) INSTALL STORM DRAIN CATCH BASIN

4 > INSTALL 24" NYLOPLAST CATCH BASIN

(4a) INSTALL 24" NYLOPLAST CATCH BASIN

(4b) INSTALL 24" NYLOPLAST CATCH BASIN

⟨4d⟩ INSTALL 24" NYLOPLAST CATCH BASIN

PER DTL ON SHT C4.8 WITH AN 18"

PER DTL ON SHT C4.8 WITH AN 24"

PER DTL ON SHT C4.8 WITH AN 18"

PER DTL ON SHT C4.8 WITH AN 18"

PER DTL ON SHT C4.8

PER MAG STD DTL 533-1

PER MAG STD DTL 535

PER DTL ON SHT C1.3

PER MAG STD DTL 537

STANDARD H-20 GRATE

PEDESTRIAN H-10 GRATE

SOLID H-20 GRATE

STANDARD H-20 GRATE

(6a) INSTALL RIP-RAP SPILLWAY

PER MAG STD DTL 206

(6c) INSTALL 4' CONCRETE SCUPPER

─ PER DTL ON SHT C1.2

iNSTALL 1' CURB OPENING AND

SPILLWAY PER DTL ON SHT C1.2

7 > INSTALL 15" HDPE STORM DRAIN PIPE

(8) INSTALL 18" HDPE STORM DRAIN PIPE

SPILLWAY PER DTL ON SHT C1.2

11 > INSTALL LOOSE RIP-RAP EROSION CONTROL

D50=6". 12" MIN DEPTH WITH GEOTEXTILE

(12) INSTALL GROUTED RIP-RAP EROSION CONTROL

(14) INSTALL BUILDING STEM WALL, MIN TOP OF

WALL ELEVATION AS SHOWN ON PLANS,

SPECIAL CONDITION FOOTING, REFER TO

SPECIAL CONDITION FOOTING, REFER TO

STRUCTURAL PLANS FOR MORE INFORMATION

 $\langle 17
angle$ SAWCUT TO A NEAT EDGE, REMOVE AND REPLACE

EXISTING ASPHALT, CURB, GUTTER, AND SIDEWALK

IN KIND PER MAG STD DTL 200-1 T TOP. TRENCH

REPAIR 3" MIN THICKNESS OR MATCH EXISTING

WHICHEVER IS GREATER. USE FULL DEPTH ABC.

STRUCTURAL PLANS FOR MORE INFO

FOOTING, MIN OF 0.5' OF COVER,

〈16〉INSTALL ROOF DRAIN INLET WITH TEE

(18) INSTALL 4" FRENCH DRAIN PER

〈19〉INSTALL SIDEWALK SCUPPER PER

(21) INSTALL 12"HDPE STORM DRAIN PIPE

(22) INSTALL 6" PVC STORM DRAIN PIPE

(25) BUILDING CONNECTION, SEE PLUMBING

 \langle 26angle INSTALL 36"X18" CONCRETE SPLASH BLOCK

 $\langle 23
angle$ INSTALL FLEX STORM PURE INLET FILTER LL

(LITTERAND LEAF BAG 22" DEPTH) PER

DTL ON SHT C1.3

LANDSCAPE PLANS

PER DTL ON SHT C1.3

(20) INSTALL SIDEWALK SCUPPER

(24) INSTALL 15"X12" HDPE TEE

PLANS FOR CONTINUATION

AT ROOFDRAIN DOWNSPOT

DEMOLITION NOTES

1) EXISTING BUILDING AND SIDEWALK

(2) EXISTING ASPHALT TO BE SAWCUT

(4) EXISTING UNDERGROUND UTILITIES

(5) EXISTING FENCE TO BE REMOVED

(6) EXISTING PLAYGROUND STRUCTURE

(6a) EXISTING PLAYGROUND STRUCTURE

(7) EXISTING CANOPY TO BE REMOVED

(8) EXISTING CMU WALL TO BE REMOVED

(9) EXISTING STORM DRAIN STRUCTURE

(10) EXISTING POWER TRANFORMER TO BE

REMOVED/RELOCATED BY UTILITY

TO BE REMOVED AND SALVAGED

(3) SAWCUT EXISTING CONCRETE.

EDGE AND REMOVE

TO BE REMOVED

TO BE REMOVED

TO BE DEMOLISHED AND REMOVED

TO A NEAT EDGE AND REMOVED

CURB AND GUTTER TO A NEAT

TO BE REMOVED OR ABANDONED

IN PLACE PER MAG SPEC 250

CLEANOUT PER DTL ON SHT C1.3

10 > INSTALL 3' CURB OPENING AND

D50=6", 8" MIN THICKNESS

(15) INSTALL BUILDING TURN DOWN

FABRIC PROTECTION



DAVID \ MALDONADO-CAMOU /

CLIENT CONTACT Dennis Roehler 9288 E. San Salvador Dr. Scottsdale, AZ 85258 480.484.8503 t PROJECT NO. DATE OF ISSUE 10.10.19 DATE REVISION NO.

12.10.19 03.25.20 05.15.20 07.15.20 10.09.20 01.12.21

PROJECT TEAM DRAWN BY **BOWMAN**

PROJECT PHASE PERMIT SE7

SHEET CONTENTS GENERAL NOTES

AND DETAILS SHEET SHEET NO.

SHT 02 OF 23

1. 1/2" THICK STEEL DIAMOND PLATE ASTM A-36. STEEL DIAMOND PLATE SHALL

2. 12"x12" AND ½" THICK STEEL DIAMOND PLATE ASTM A-36 WITH 1" DIAMETER

PERFORATIONS (TOTAL OF 36). STEEL DIAMOND PLATE SHALL BE PRIMED AND

PAINTED (2 COATS MIN.) WITH A HIGH GLOSS HEAVY DUTY INDUSTRIAL ENAMEL PAINT W/ UV

3. STEEL DIAMOND PLATE SHALL BE DELIVERED AS ONE PIECE, CONFORMING TO

THE REQUIRED SCUPPER DIMENSIONS. PLATES SHALL NOT BE SPLICED.


PAINT W/ UV INHIBITORS.

INHIBITORS.

BE PRIMED AND PAINTED (2 COATS MIN.) WITH A HIGH GLOSS HEAVY DUTY INDUSTRIAL ENAMEL

EXPANSION

JOINTS (TYP)

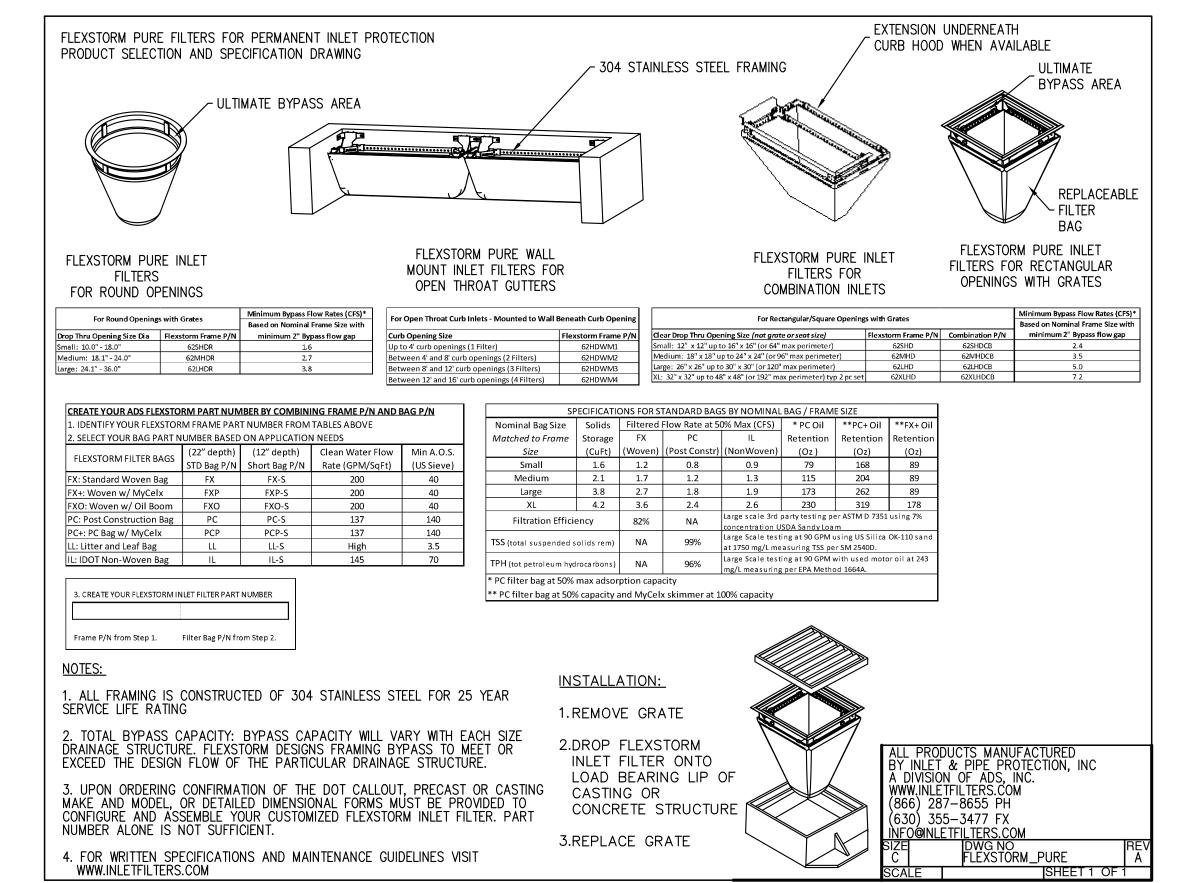



S ntar

CLIENT CONTACT

Dennis Roehler

480.484.8503 t

PROJECT NO.

REVISION NO.

PROJECT TEAM

BOWMAN

PROJECT PHASE

PERMIT SET

SHEET CONTENTS

SHEET

SHEET NO.

050641-01-001

9288 E. San Salvador Dr.

DATE OF ISSUE

10.10.19

12.10.19

03.25.20

05.15.20

10.09.20

DRAWN BY

Scottsdale, AZ 85258


2929 n central ave phoenix arizona 85012 oneil.t@owp.com 602.257.1764 t 602.257.9029 f www.owp.com

\ MALDONADO-CAMOU



SHT **03** OF **23**

GENERAL DETAILS

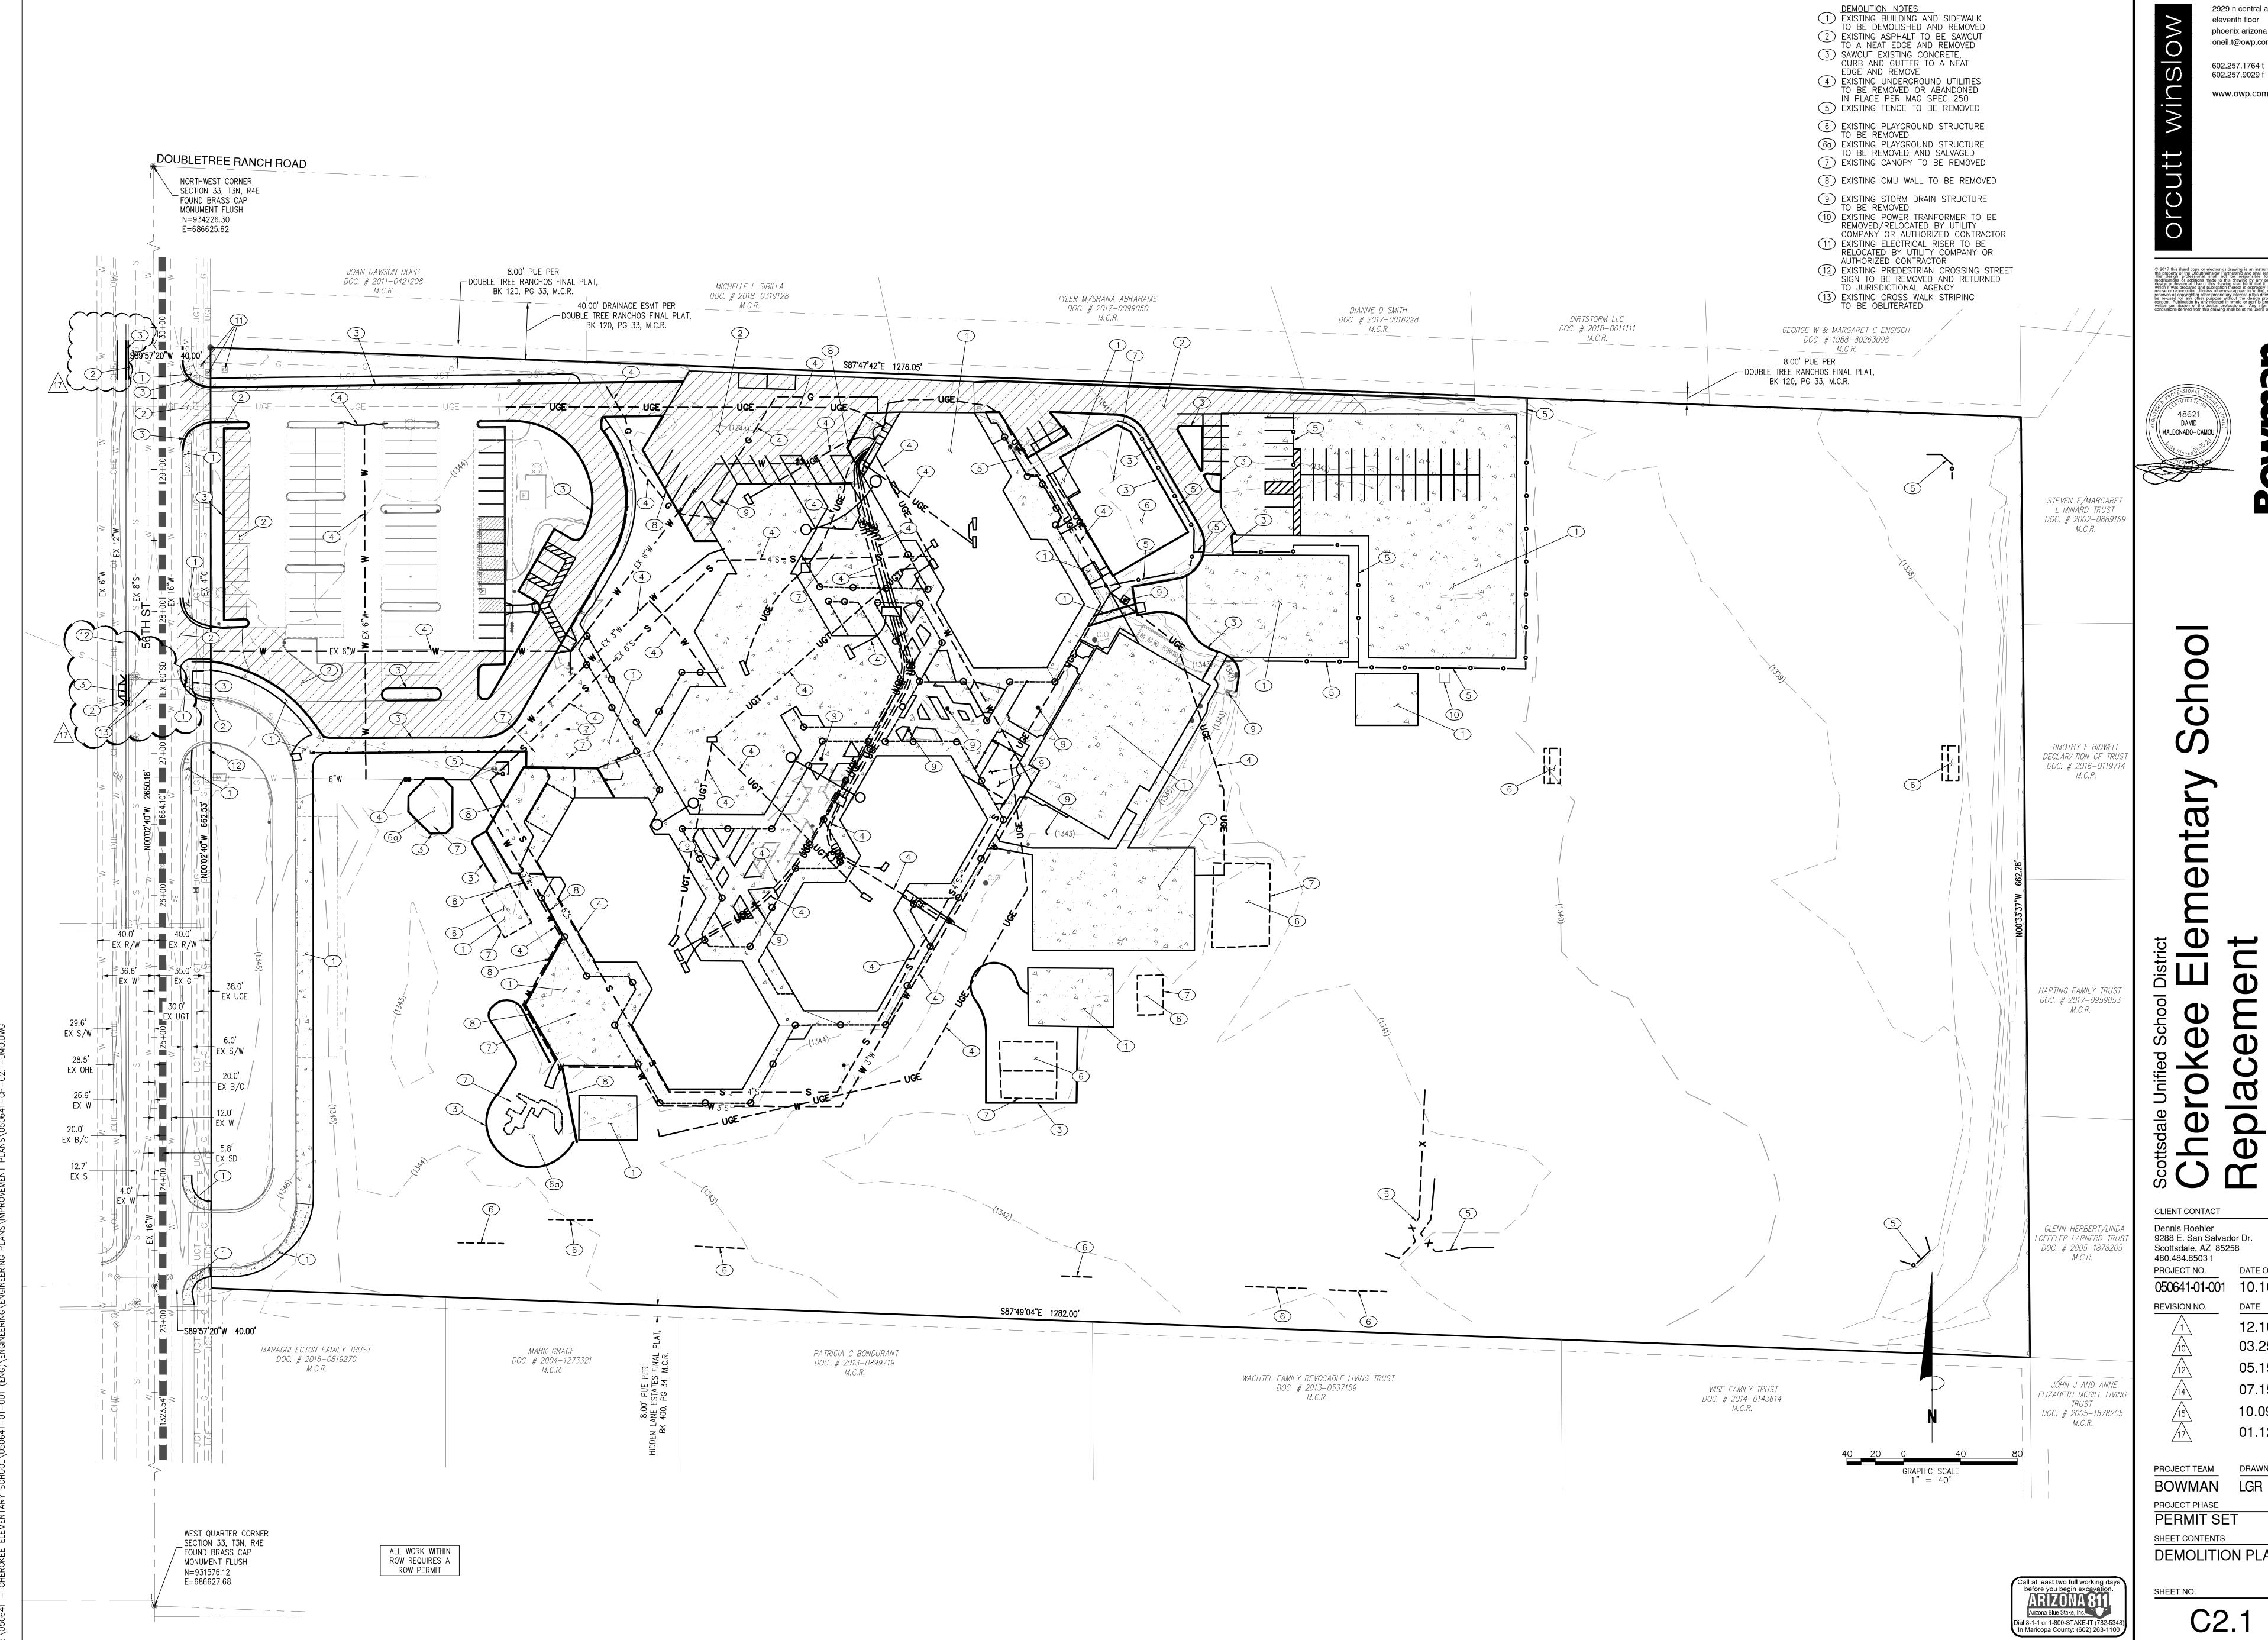

2929 n central ave eleventh floor phoenix arizona 85012 oneil.t@owp.com 602.257.1764 t

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10.10.19 12.10.19 03.25.20


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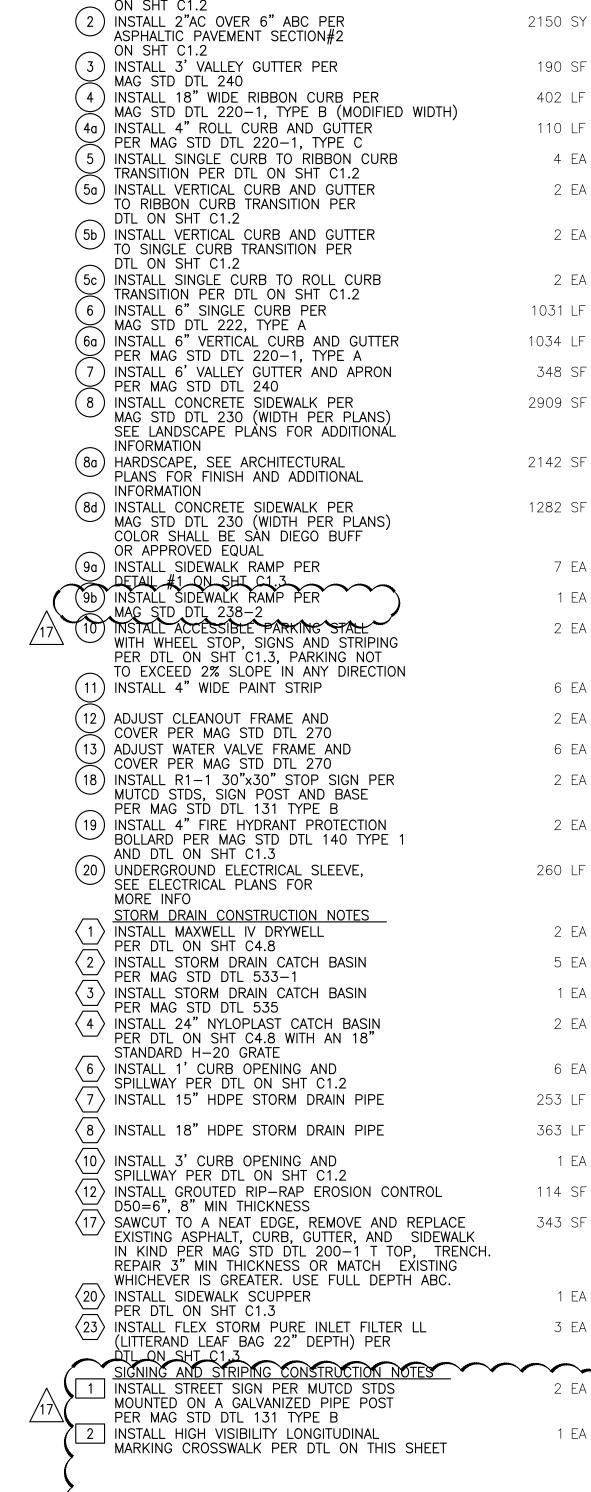
DEMOLITION PLAN

ALL WORK WITHIN

ROW REQUIRES A ROW PERMIT




FOR MORE INFORMATION

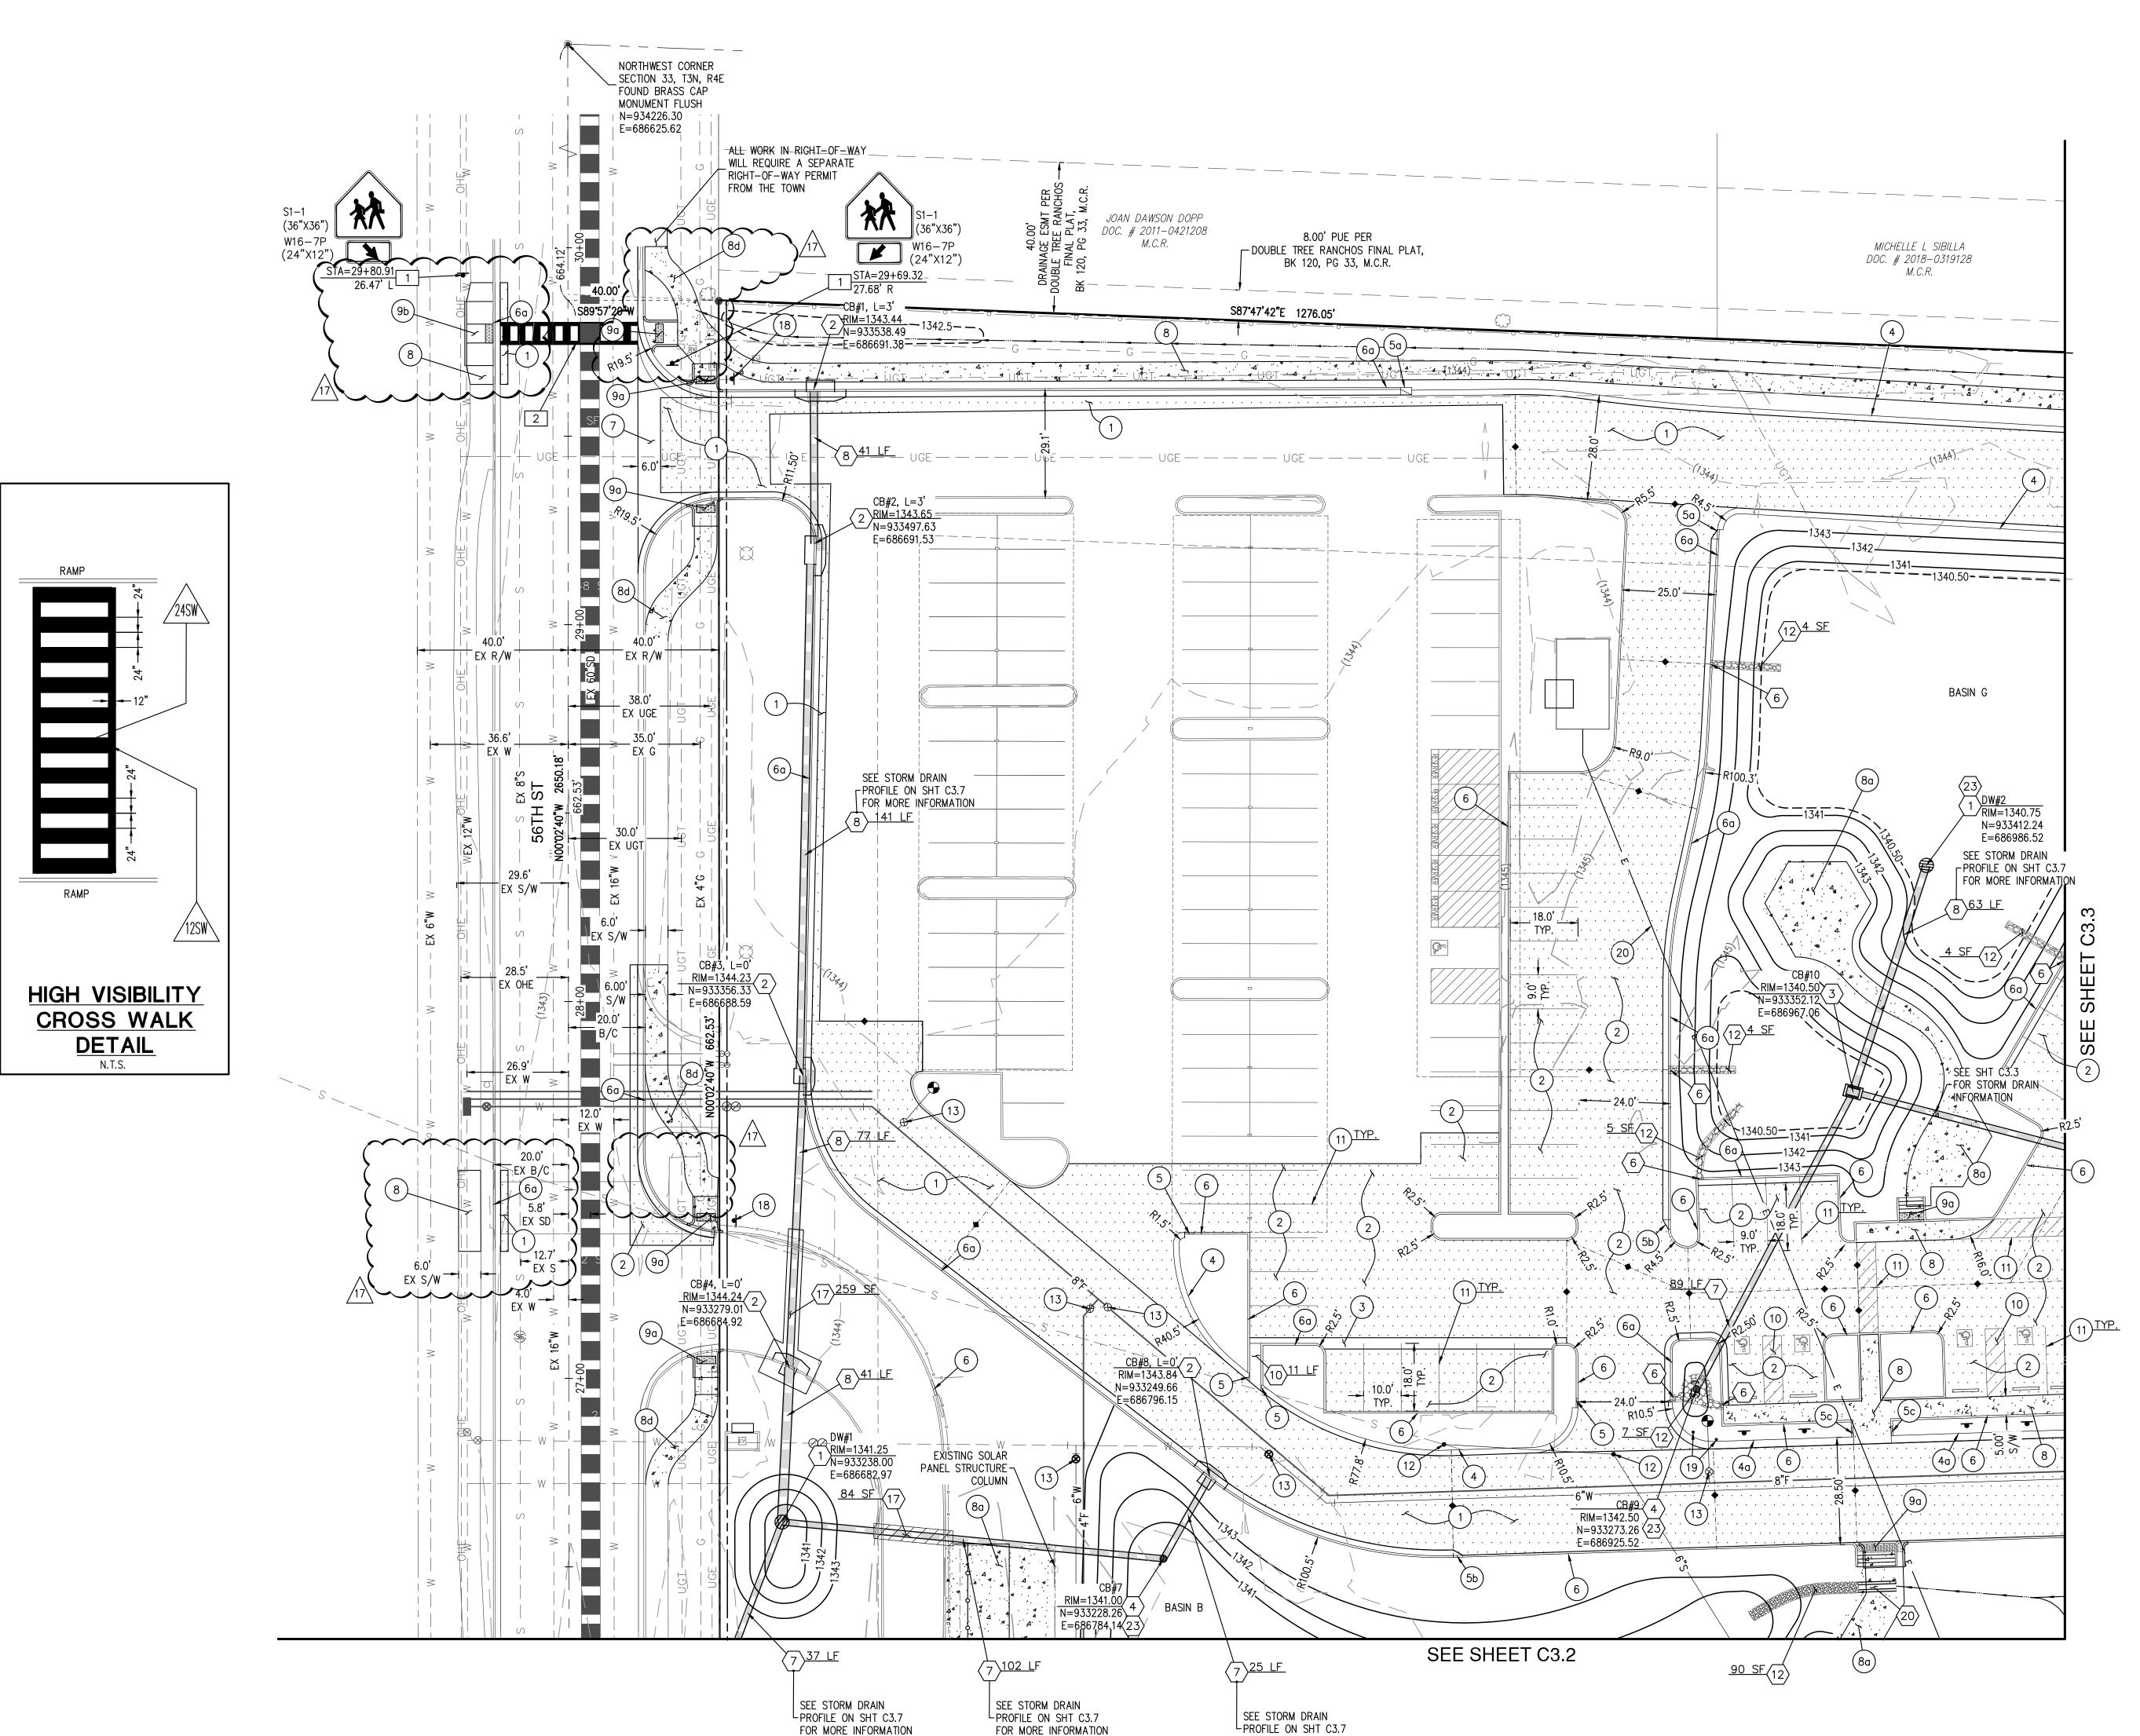


1) PAVING CONSTRUCTION NOTES
INSTALL 3" AC OVER 6"ABC PER
ASPHALTIC PAVILATION OF A PER

ON SHT C1.2

ASPHALTIC PAVEMENT SECTION#1

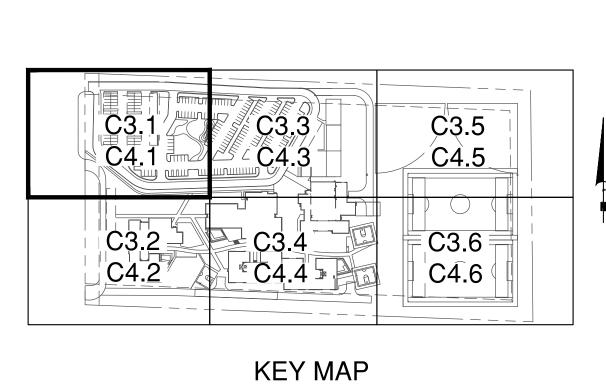

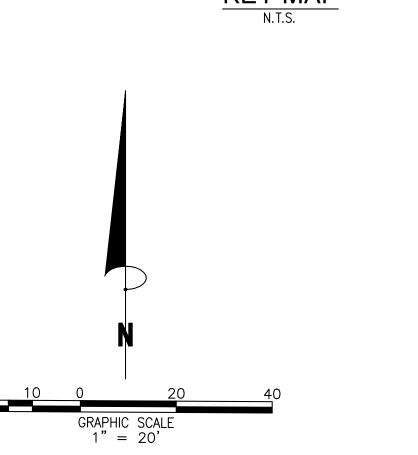



2929 n central ave

oneil.t@owp.com

602.257.1764 t

602.257.9029 f

www.owp.com

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phoenix arizona 85012

1738 SY

CLIENT CONTACT Dennis Roehler 9288 E. San Salvador Dr.

Scottsdale, AZ 85258 480.484.8503 t PROJECT NO. DATE OF ISSUE 10.10.19 REVISION NO. 12.10.19 03.25.20 05.15.20 07.15.20 10.09.20

01.12.21 PROJECT TEAM DRAWN BY

BOWMAN PROJECT PHASE

PERMIT SET SHEET CONTENTS

PAVING PLAN

Ab RIM=1344.46 N=933203.06

PROFILE ON SHT C3.77

FOR MORE INFORMATION

—— — → UGT +1

| \geq

40.0'

EX R/W^r

E=686669.73

4 RIM=1341.00 N=933179.31

E=686680.05

EXISTING SOLAR 4 PANEL STRUCTURE :

COLUMN

PAVING CONSTRUCTION NOTES (8) INSTALL CONCRETE SIDEWALK PER MAG STD DTL 230 (WIDTH PER PLANS) SEE LANDSCAPE PLANS FOR ADDITIONAL INFORMATION

HARDSCAPE, SEE ARCHITECTURAL
PLANS FOR FINISH AND ADDITIONAL INFORMATION (8b) INSTALL GRASSPAVE2 FIRE LANE PER SECTION#3 ON SHT C1.2 (8c) INSTALL DG FIRE LANE PER SECTION#4 ON SHT C1.2 INSTALL CONCRETE SIDEWALK PER
MAG STD DTL 230 (WIDTH PER PLANS)
COLOR SHALL BE SAN DIEGO BUFF
OR APPROVED EQUAL

INSTALL SIDEWALK RAMP

PER MAC STD DTL 237 7 ✓ PER MAG STD DTL 237-3 (12) ADJUST CLEANOUT FRAME AND COVER PER MAG STD DTL 270 (12a) ADJUST MANHOLE FRAME AND COVER PER MAG STD DTL 422 (12b) ADJUST MANHOLE FRAME AND COVER PER MAG STD DTL 422, CONCRETE COLLAR SHALL BE BLACK CONCRETE.

(13) ADJUST WATER VALVE FRAME AND COVER PER MAG STD DTL 270 (13a) ADJUST WATER VALVE FRAME AND COVER PER MAG STD DTL 270, CONCRETE COLLAR SHALL BE BLACK CONCRETE

(17) INSTALL 25' COMMERCIAL DRIVEWAY ✓ PER MAG STD DTL 250-2 (19) INSTALL 4" FIRE HYDRANT PROTECTION BOLLARD PER MAG STD DTI 140 TYPE $^\prime$ BOLLARD PER MAG STD DTL 140 TYPE 1 AND DTL ON SHT C1.3

UNDERGROUND ELECTRICAL SLEEVE, SEE ELECTRICAL PLANS FOR

RAISED WALL SEE CHEROKEE

(12) 74 SF

SEE SHEET C3.1

⊗ / **> ⊗** 3"W

EXISTING SOLAR

COLUMN

>- PANEL STRUCTURE

BASIN B

ELEMENTARY SCHOOL

LANDSCAPE PLANS FOR

MORE INFO

(21) UNDERGROUND ELECTRICAL RISER, SEE ELECTRICAL PLANS FOR MORE INFO 22) INSTALL SAFETY FENCE, SEE ARCHITECTURAL PLANS FOR MORE INFO STORM DRAIN CONSTRUCTION NOTES
INSTALL 24" NYLOPLAST CATCH BASIN PER DTL ON SHT C4.8 WITH AN 18"

STANDARD H-20 GRATE (4a) INSTALL 24" NYLOPLAST CATCH BASIN PER DTL ON SHT C4.8 WITH AN 18" PEDESTRIAN H-10 GRATE (4b) INSTALL 24" NYLOPLAST CATCH BASIN

PER DTL ON SHT C4.8 WITH AN 18" SOLID H-20 GRATE (7) INSTALL 15" HDPE STORM DRAIN PIPE (12) INSTALL GROUTED RIP-RAP EROSION CONTROL D50=6", 8" MIN THICKNESS (16) INSTALL ROOF DRAIN INLET WITH TEE CLEANOUT PER DTL ON SHT C1.3


(18) INSTALL 4" FRENCH DRAIN PER DTL ON SHT C1.3


(19) INSTALL SIDEWALK SCUPPER PER LANDSCAPE PLANS 20 INSTALL SIDEWALK SCUPPER PER DTL ON SHT C1.3 $\langle 21 \rangle$ INSTALL 12"HDPE STORM DRAIN PIPE

(23) INSTALL FLEX STORM PURE INLET FILTER LL (LITTERAND LEAF BAG 22" DEPTH) PER DTL ON SHT C1.3

C3.2 C3.6 C3.4 C4.6

KEY MAP

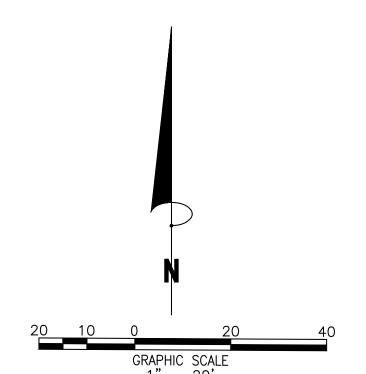

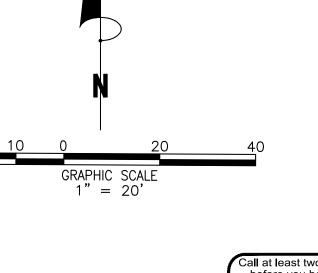



S

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602.257.1764 t

602.257.9029 f

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DAVID \\ MALDONADO-CAMOU / ,

phoenix arizona 85012 oneil.t@owp.com

CLIENT CONTACT Dennis Roehler 9288 E. San Salvador Dr. Scottsdale, AZ 85258

480.484.8503 t PROJECT NO. DATE OF ISSUE 050641-01-001 10.10.19

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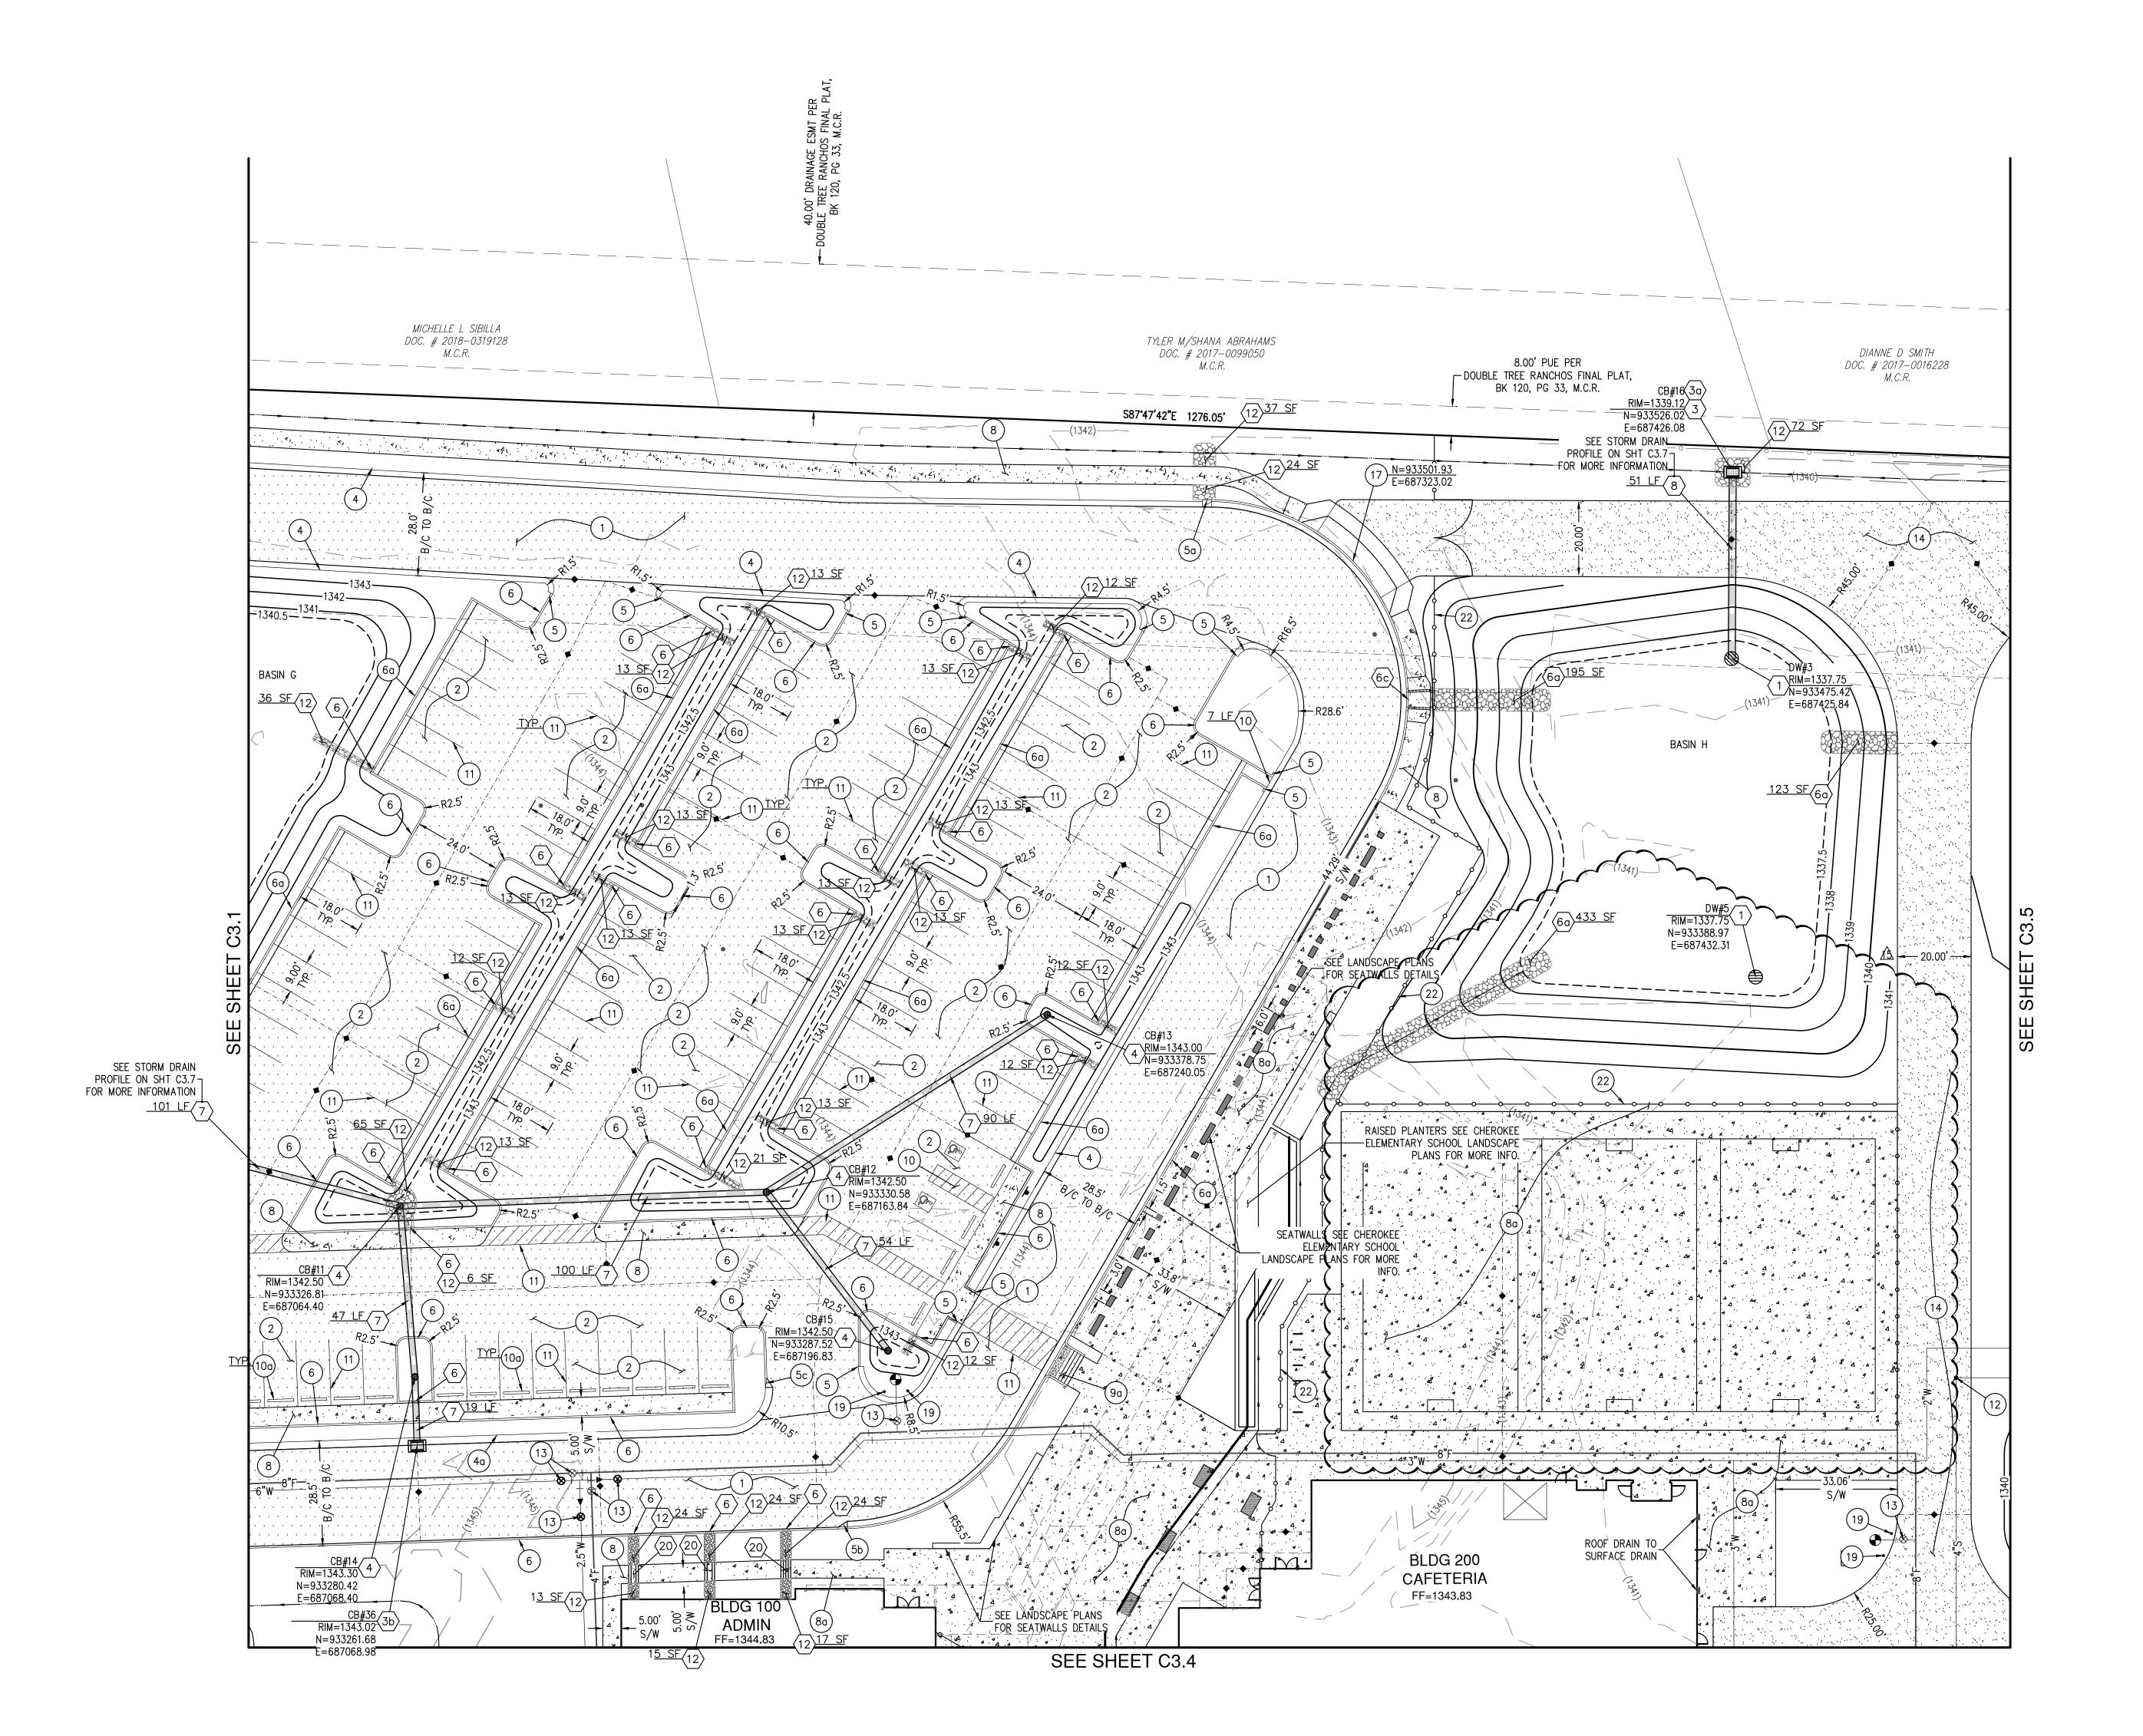
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SHEET CONTENTS

PAVING PLAN

SHEET NO.

Dial 8-1-1 or 1-800-STAKE-IT (782-5348 In Maricopa County: (602) 263-1100



PAVING CONSTRUCTION NOTES

1) INSTALL 3" AC OVER 6"ABC PER ASPHALTIC PAVEMENT SECTION#1 → ON SHT C1.2 2 INSTALL 2"AC OVER 6" ABC PER ASPHALTIC PAVEMENT SECTION#2 ON SHT C1.2 4) INSTALL 18" WIDE RIBBON CURB PER MAG STD DTL 220-1, TYPE B (MODIFIED WIDTH) (4a) INSTALL 4" ROLL CURB AND GUTTER PER MAG STD DTL 220-1, TYPE C (5) INSTALL SINGLE CURB TO RIBBON CURB TRANSITION PER DTL ON SHT C1.2 (5a) INSTALL VERTICAL CURB AND GUTTER TO RIBBON CURB TRANSITION PER \frown DTL ON SHT C1.2 (5b) INSTALL VERTICAL CURB AND GUTTER TO SINGLE CURB TRANSITION PER DTL ON SHT C1.2 (5c) INSTALL SINGLE CURB TO ROLL CURB TRANSITION PER DTL ON SHT C1.2 6 INSTALL 6" SINGLE CURB PER MAG STD DTL 222, TYPE A (6a) INSTALL 6" VERTICAL CURB AND GUTTER PER MAG STD DTL 220-1, TYPE A 8) INSTALL CONCRETE SIDEWALK PER MAG STD DTL 230 (WIDTH PER PLANS) SEE LANDSCAPE PLANS FOR ADDITIONAL INFORMATION (8a) HARDSCAPE, SEE ARCHITECTURAL PLANS FOR FINISH AND ADDITIONAL INFORMATION (9a) INSTALL SIDEWALK RAMP PER DETAIL #1 ON SHT C1.3 (10) INSTALL ACCESSIBLE PARKING STALL WITH WHEEL STOP, SIGNS AND STRIPING PER DTL ON SHT C1.3, PARKING NOT TO EXCEED 2% SLOPE IN ANY DIRECTION (10a) INSTALL CONCRETE WHEEL STOP PER DTL ON SHT C1.3 11) INSTALL 4" WIDE PAINT STRIP 12) ADJUST CLEANOUT FRAME AND COVER PER MAG STD DTL 270 13) ADJUST WATER VALVE FRAME AND COVER PER MAG STD DTL 270 [14] INSTALL 6" CONCRETE PAVEMENT PER SECTION#3 ON SHT C1.2 17) INSTALL 25' COMMERCIAL DRIVEWAY PER MAG STD DTL 250-2 (19) INSTALL 4" FIRE HYDRANT PROTECTION BOLLARD PER MAG STD DTL 140 TYPE 1 AND DTL ON SHT C1.3 (22) INSTALL SAFETY FENCE, SEE ARCHITECTURAL PLANS FOR MORE INFÓ STORM DRAIN CONSTRUCTION NOTES 1 > INSTALL MAXWELL IV DRYWELL PER DTL ON SHT C4.8 3 INSTALL STORM DRAIN CATCH BASIN PER MAG STD DTL 535 (3a) INSTALL GROUTED RIP-RAP APRON PER DTL ON SHT C1.3 (3b) INSTALL STORM DRAIN CATCH BASIN PER MAG STD DTL 537 \langle 4 \rangle INSTALL 24" NYLOPLAST CATCH BASIN PER DTL ON SHT C4.8 WITH AN 18" STANDARD H-20 GRATE (6) INSTALL 1' CURB OPENING AND SPILLWAY PER DTL ON SHT C1.2 (6a) INSTALL RIP-RAP SPILLWAY PER DTL ON SHT C1.2 (6c) INSTALL 4' CONCRETE SCUPPER

PER MAG STD DTL 206


(20) INSTALL SIDEWALK SCUPPER PER DTL ON SHT C1.3

 $\langle 7 \rangle$ INSTALL 15" HDPE STORM DRAIN PIPE


(8) INSTALL 18" HDPE STORM DRAIN PIPE

10 INSTALL 3' CURB OPENING AND SPILLWAY PER DTL ON SHT C1.2

12 INSTALL GROUTED RIP—RAP EROSION CONTROL D50=6", 8" MIN THICKNESS

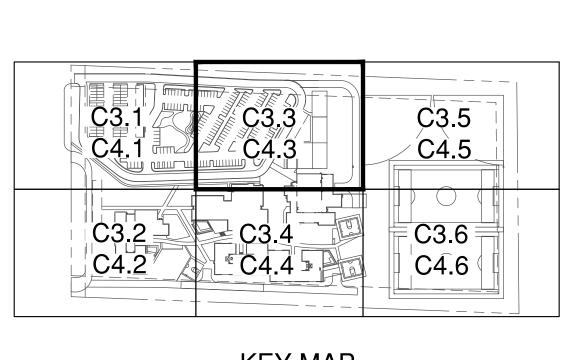



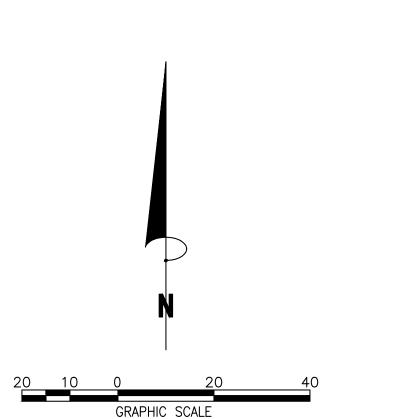



2929 n central ave

oneil.t@owp.com

602.257.1764 t

602.257.9029 f

48621

DAVID

∖\maldonado-camou*],*

www.owp.com

phoenix arizona 85012

CLIENT CONTACT

Dennis Roehler 9288 E. San Salvador Dr. Scottsdale, AZ 85258 480.484.8503 t PROJECT NO. DATE OF ISSUE 050641-01-001 10.10.19

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SHEET CONTENTS PAVING PLAN

SEE SHEET C3.3

12)29 SF

PLANS FOR FINISH AND ADDITIONAL INFORMATION

(8b) INSTALL GRASSPAVE2 FIRE LANE \prec PER SECTION#3 ON SHT C1.2 (8c) INSTALL DG FIRE LANE PER \prec SECTION#4 ON SHT C1.2 (12) ADJUST CLEANOUT FRAME AND COVER PER MAG STD DTL 270 (12a) ADJUST MANHOLE FRAME AND COVER \prec PER MAG STD DTL 422 (13) ADJUST WATER VALVE FRAME AND \prec COVER PER MAG STD DTL 270

14 INSTALL 6" CONCRETE PAVEMENT PER SECTION#3 ON SHT C1.2 (19) INSTALL 4" FIRE HYDRANT PROTECTION BOLLARD PER MAG STD DTL 140 TYPE 1

AND DTL ON SHT C1.3

UNDERGROUND ELECTRICAL SLEEVE,
SEE FLECTRICAL PLANS FOR SEE ELECTRICAL PLANS FOR

STANDARD H-20 GRATE

ROOF DRAIN TO_ SURFACE DRAIN

BLDG 200

CAFETERIA

MORE INFO STORM DRAIN CONSTRUCTION NOTES
INSTALL STORM DRAIN CATCH BASIN
PER MAG STD DTL 535 4 INSTALL 24" NYLOPLAST CATCH BASIN PER DTL ON SHT C4.8 WITH AN 18"

(40) INSTALL 24" NYLOPLAST CATCH BASIN PER DTL ON SHT C4.8 WITH AN 18" PEDESTRIAN H-10 GRATE (4b) INSTALL 24" NYLOPLAST CATCH BASIN

PER DTL ON SHT C4.8 WITH AN 18"
SOLID H-20 GRATE (4d) INSTALL 24" NYLOPLAST CATCH BASIN PER DTL ON SHT C4.8 WITH AN 24" STANDARD H-20 GRATE $\langle 7 \rangle$ INSTALL 15" HDPE STORM DRAIN PIPE

11) INSTALL LOOSE RIP-RAP EROSION CONTROL D50=6", 12" MIN DEPTH WITH GEOTEXTILE FABRIC PROTECTION (12) INSTALL GROUTED RIP-RAP EROSION CONTROL D50=6", 8" MIN THICKNESS (14) INSTALL BUILDING STEM WALL, MIN TOP OF WALL ELEVATION AS SHOWN ON PLANS,

SPECIAL CONDITION FOOTING, REFER TO STRUCTURAL PLANS FOR MORE INFO 15) INSTALL BUILDING TURN DOWN FOOTING, MIN OF 0.5' OF COVER, SPECIAL CONDITION FOOTING, REFER TO STRUCTURAL PLANS FOR MORE INFORMATION (16) INSTALL ROOF DRAIN INLET WITH TEE CLEANOUT PER DTL ON SHT C1.3 (18) INSTALL 4" FRENCH DRAIN PER DTL ON SHT C1.3

LANDSCAPE PLANS (20) INSTALL SIDEWALK SCUPPER PER DTL ON SHT C1.3 (21) INSTALL 12"HDPE STORM DRAIN PIPE (22) INSTALL 6" PVC STORM DRAIN PIPE


(19) INSTALL SIDEWALK SCUPPER PER

(23) INSTALL FLEX STORM PURE INLET FILTER LL (LITTERAND LEAF BAG 22" DEPTH) PER DTL ON SHT C1.3

 $\langle 24 \rangle$ INSTALL 15"X12" HDPE TEE 25) BUILDING CONNECTION, SEE PLUMBING PLANS FOR CONTINUATION 26 INSTALL 36"X18" CONCRETE SPLASH BLOCK AT ROOFDRAIN DOWNSPOT

C4.2 C4.6

KEY MAP

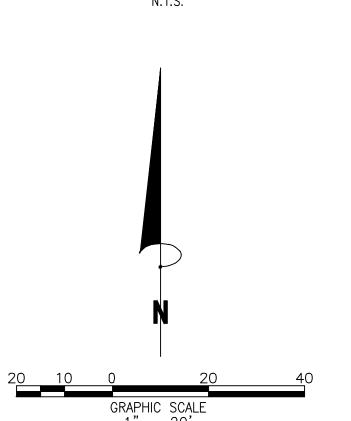



DAVID

\\ MALDONADO−CAMOU / ,

2929 n central ave eleventh floor

oneil.t@owp.com

602.257.1764 t

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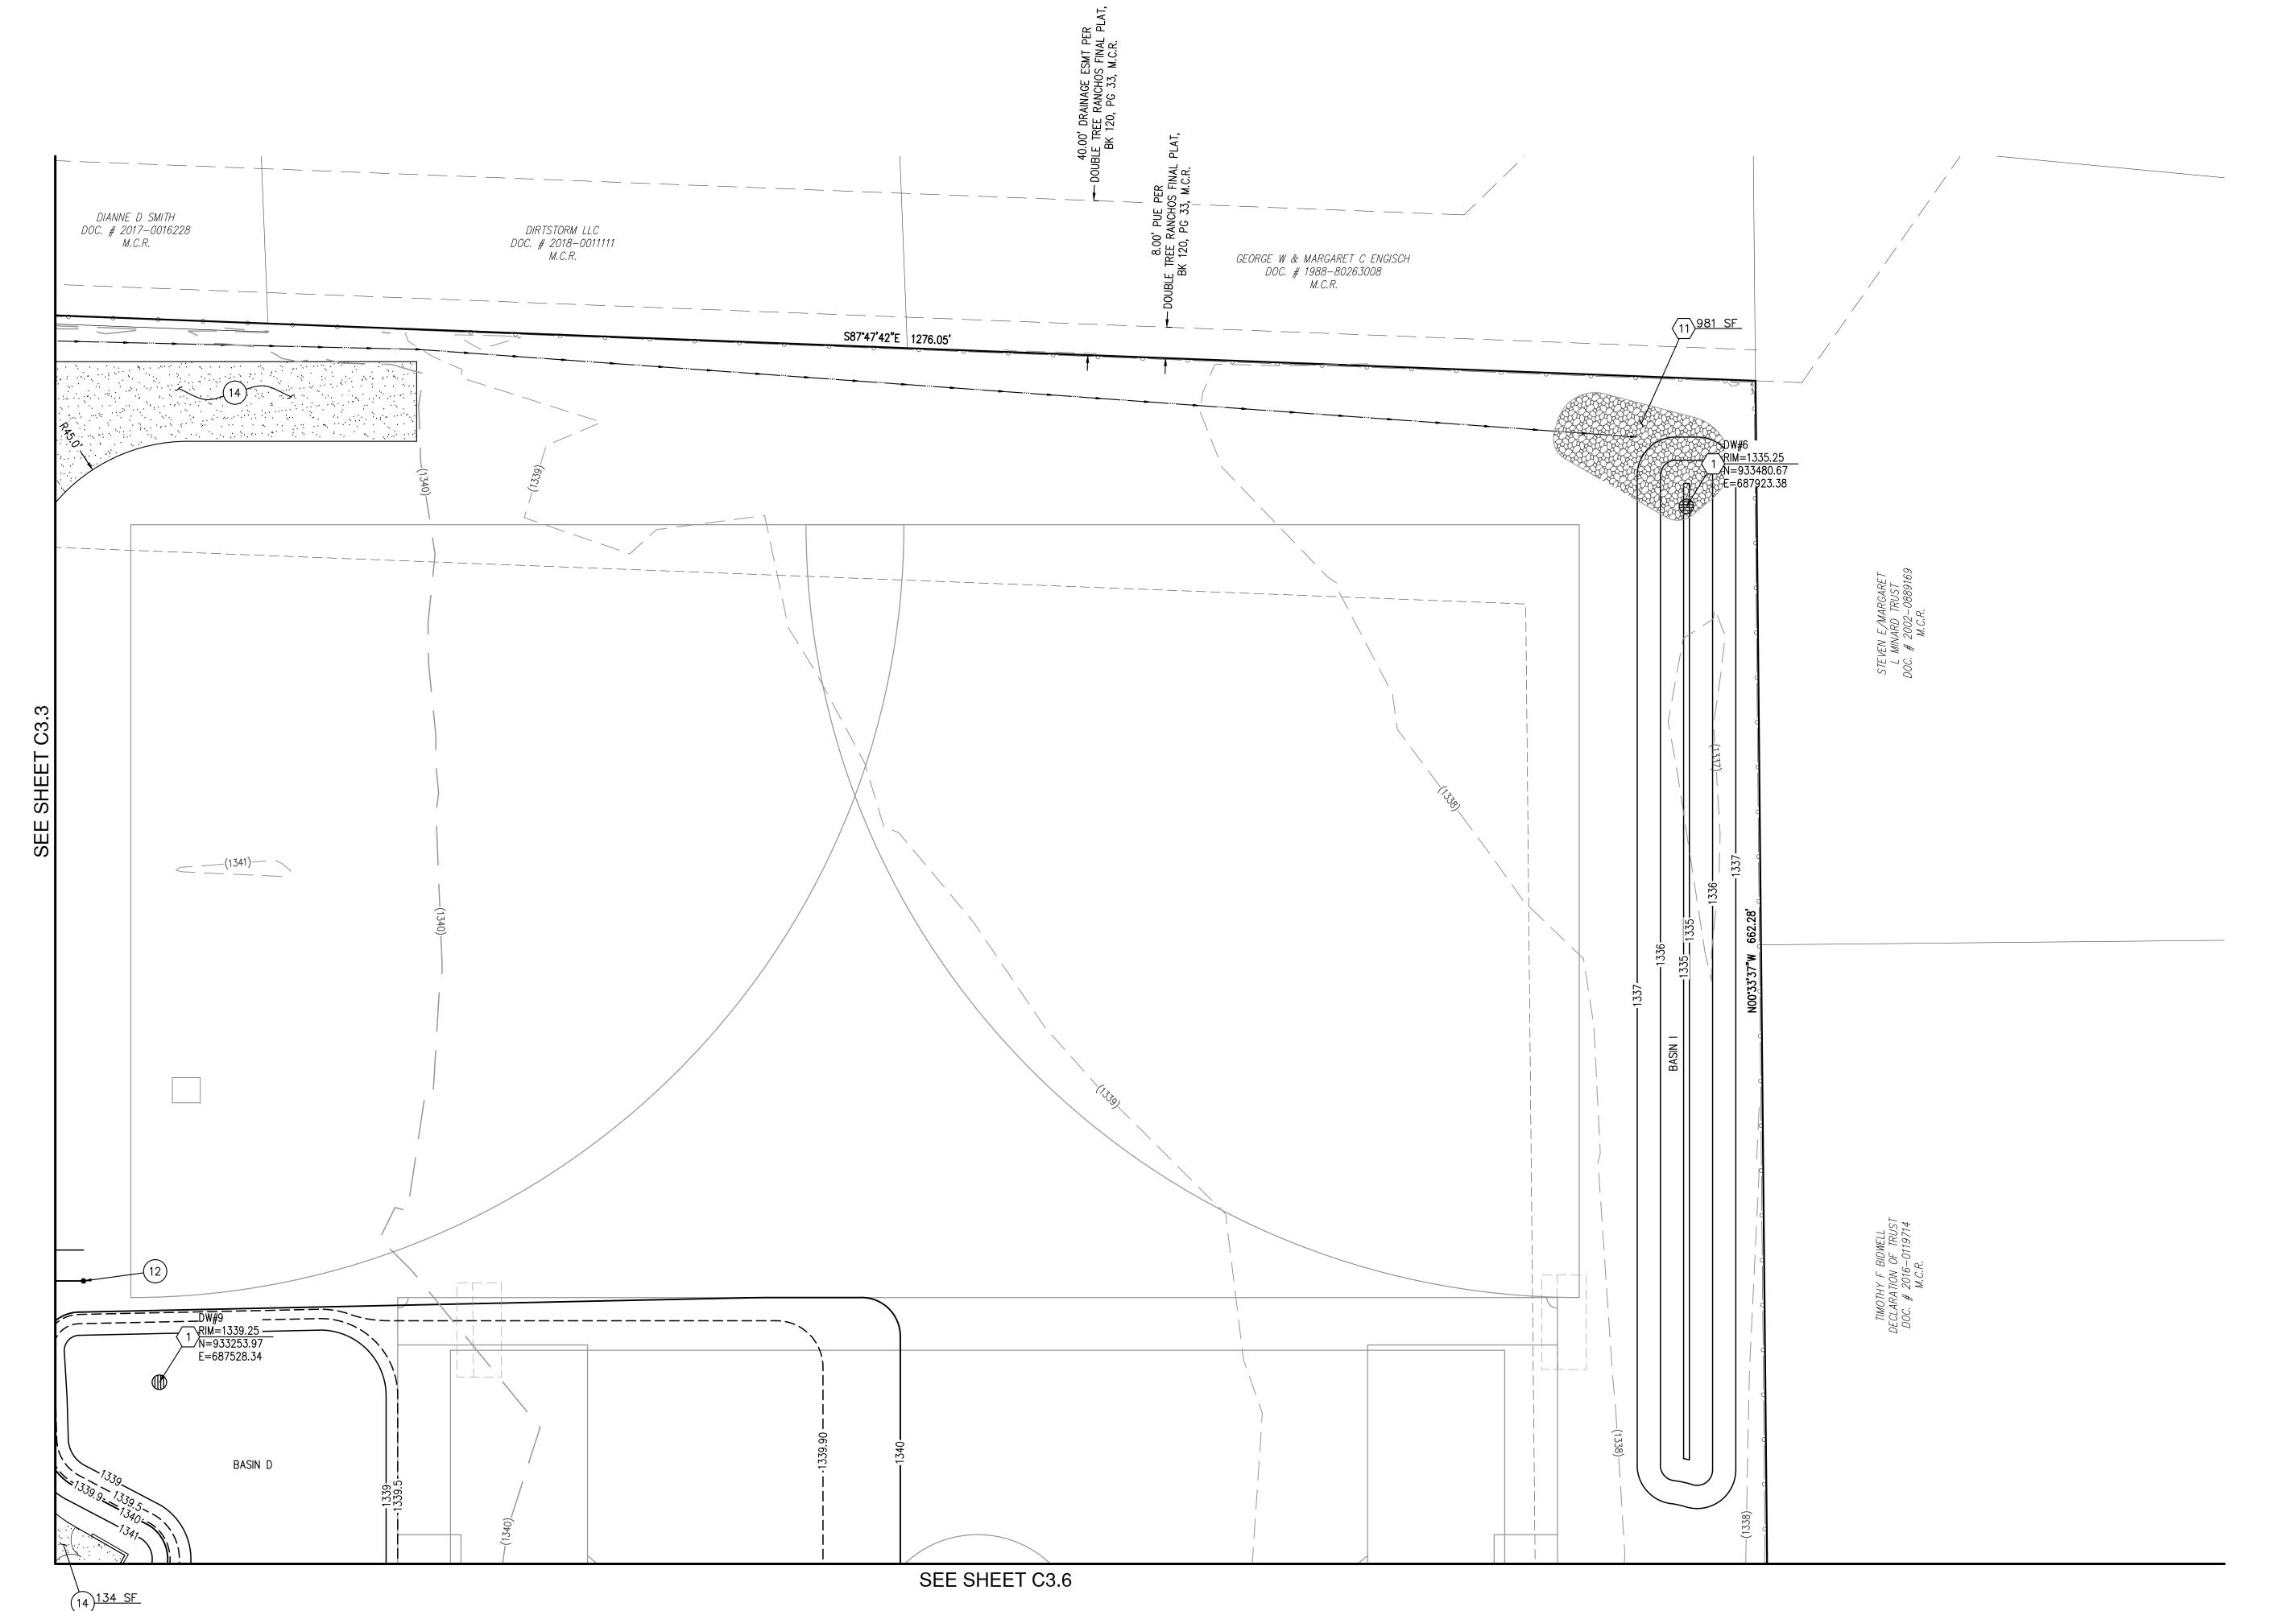
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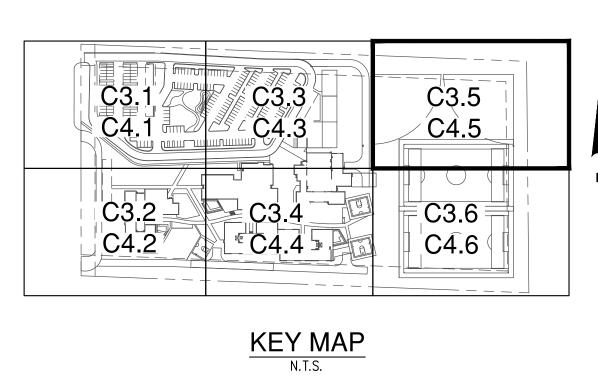
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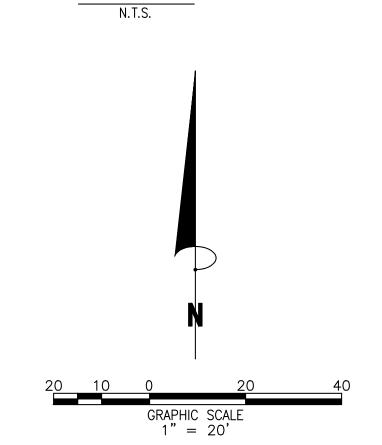
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SHEET CONTENTS

PAVING PLAN









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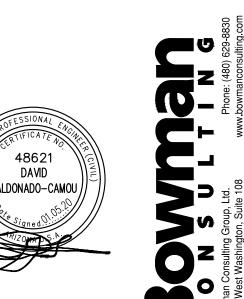
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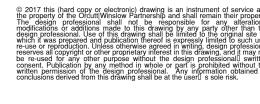
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SHEET CONTENTS PAVING PLAN

PAVING CONSTRUCTION NOTES

HARDSCAPE, SEE ARCHITECTURAL
PLANS FOR FINISH AND ADDITIONAL

INFORMATION



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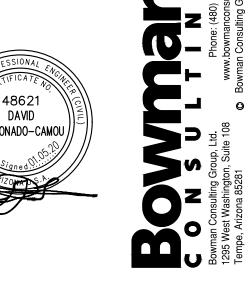
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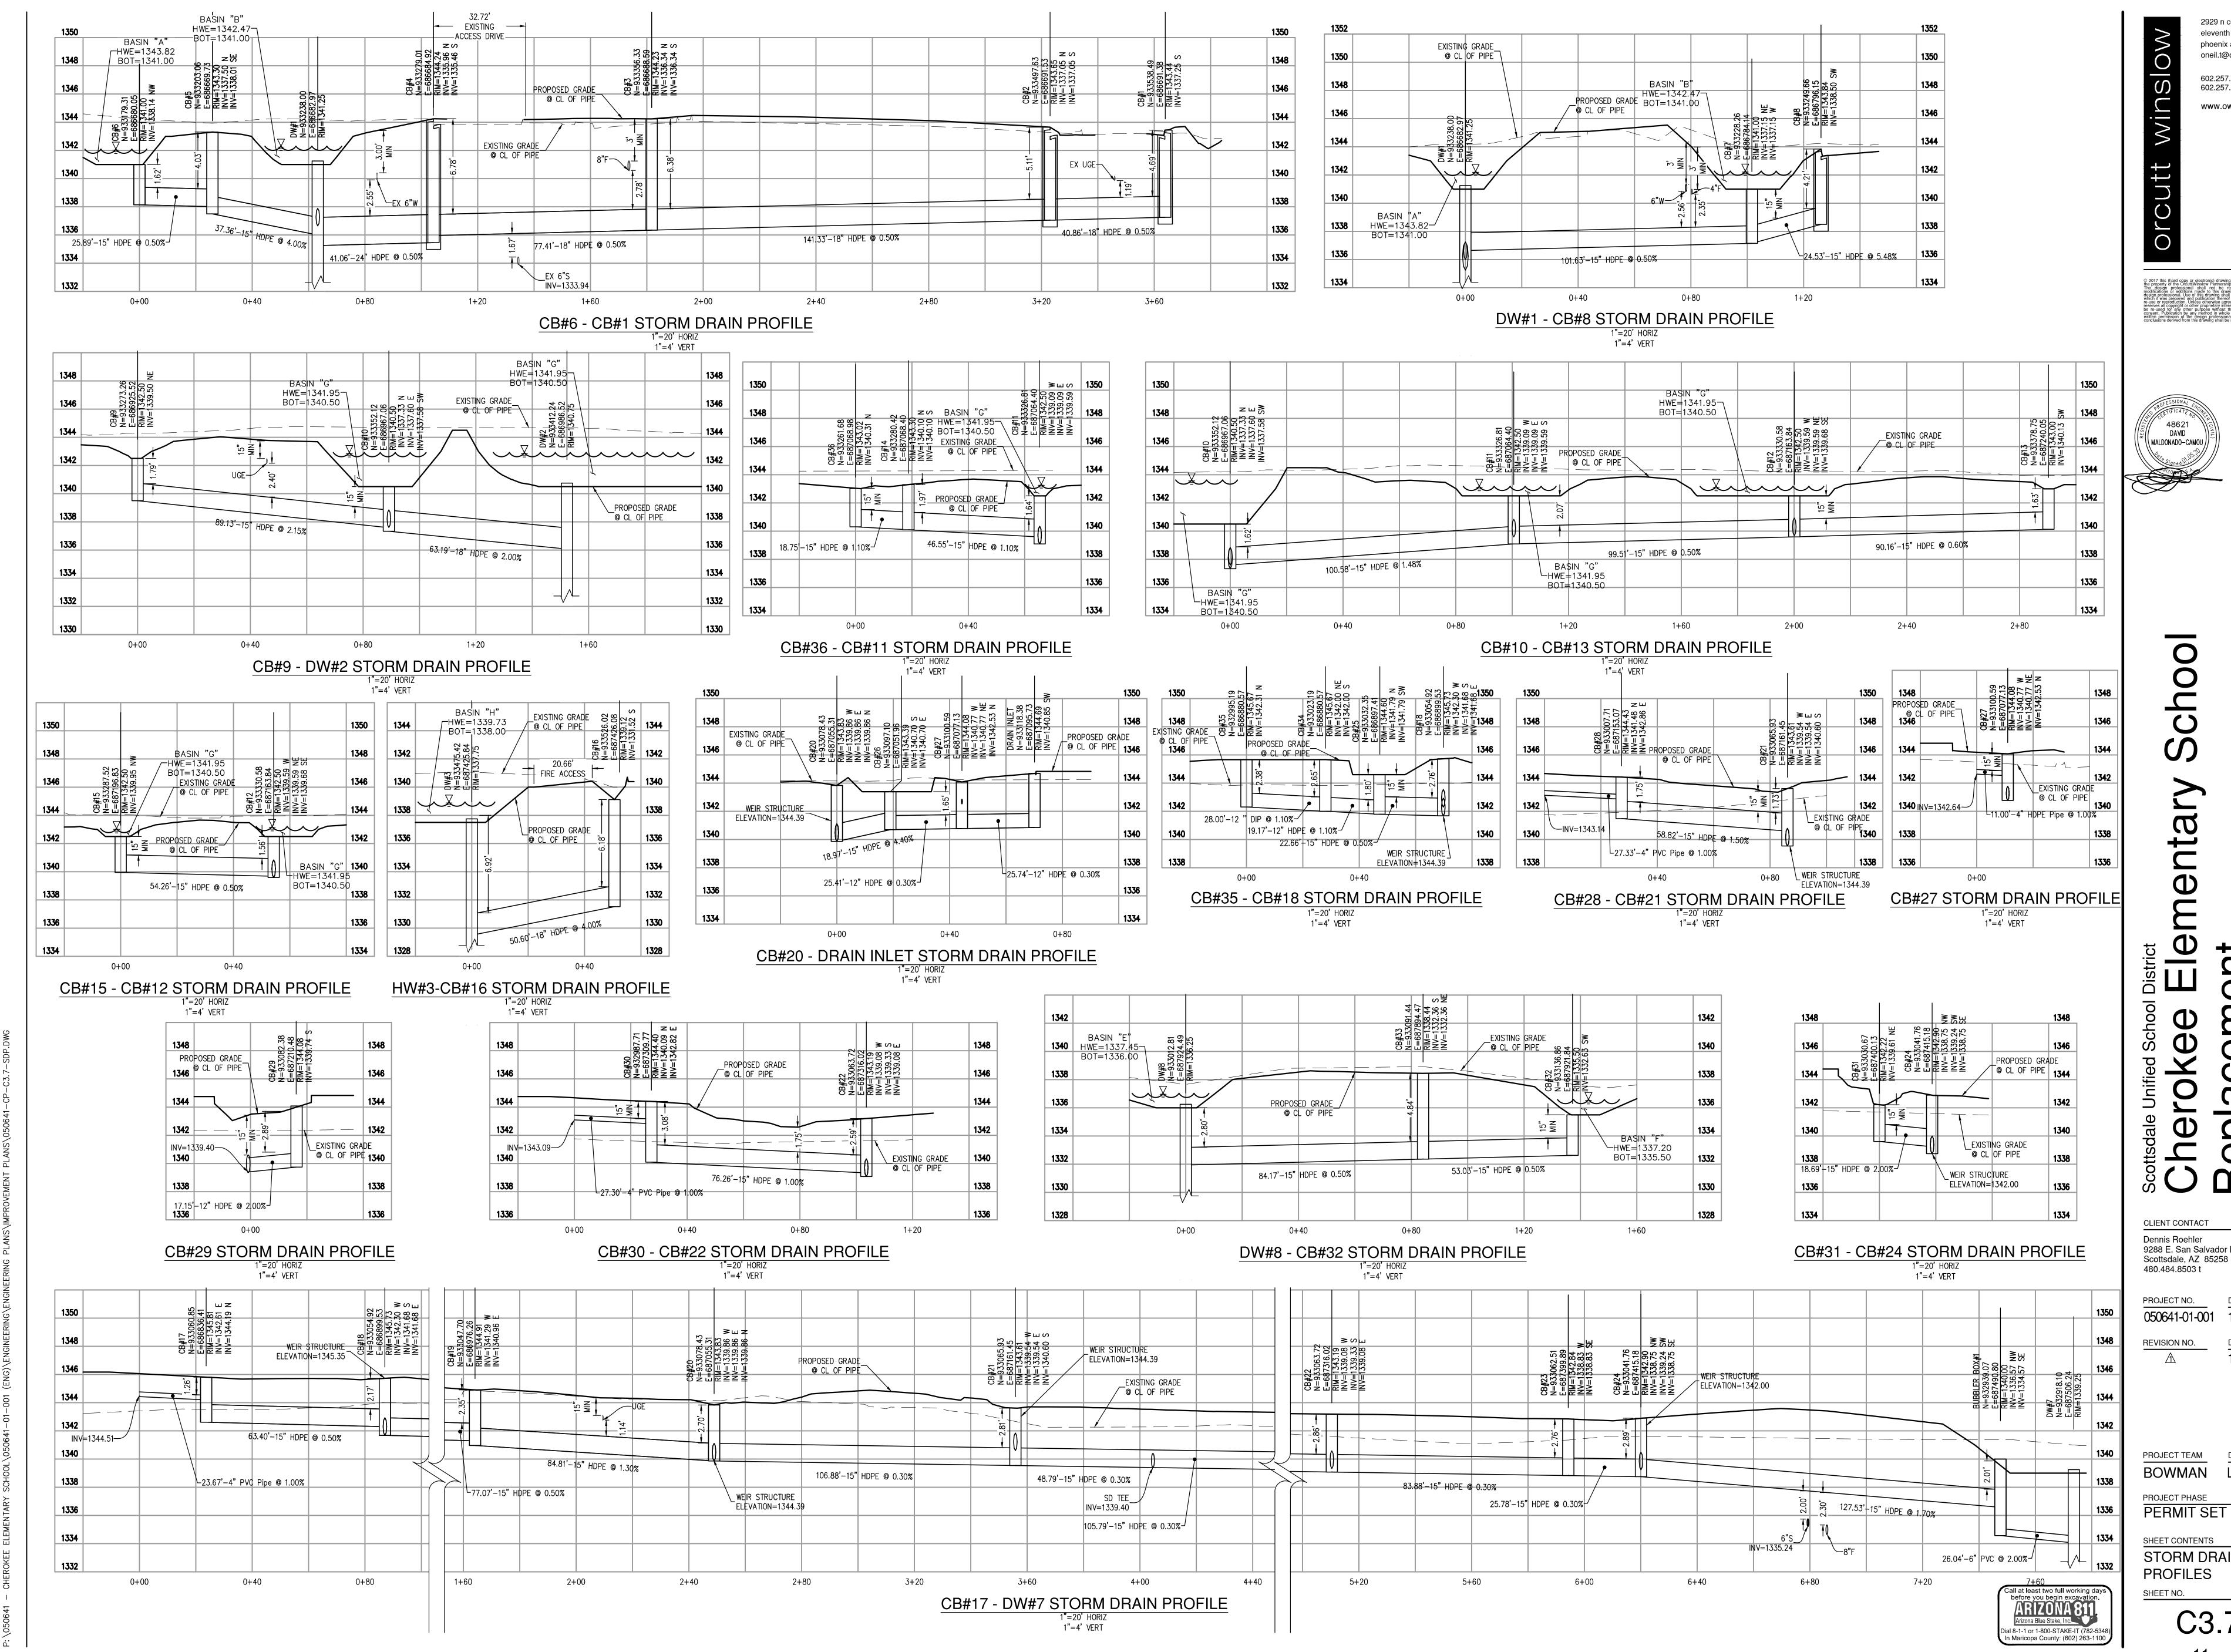
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SHEET CONTENTS


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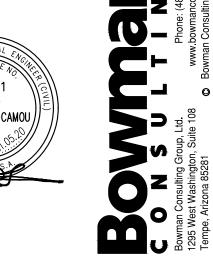


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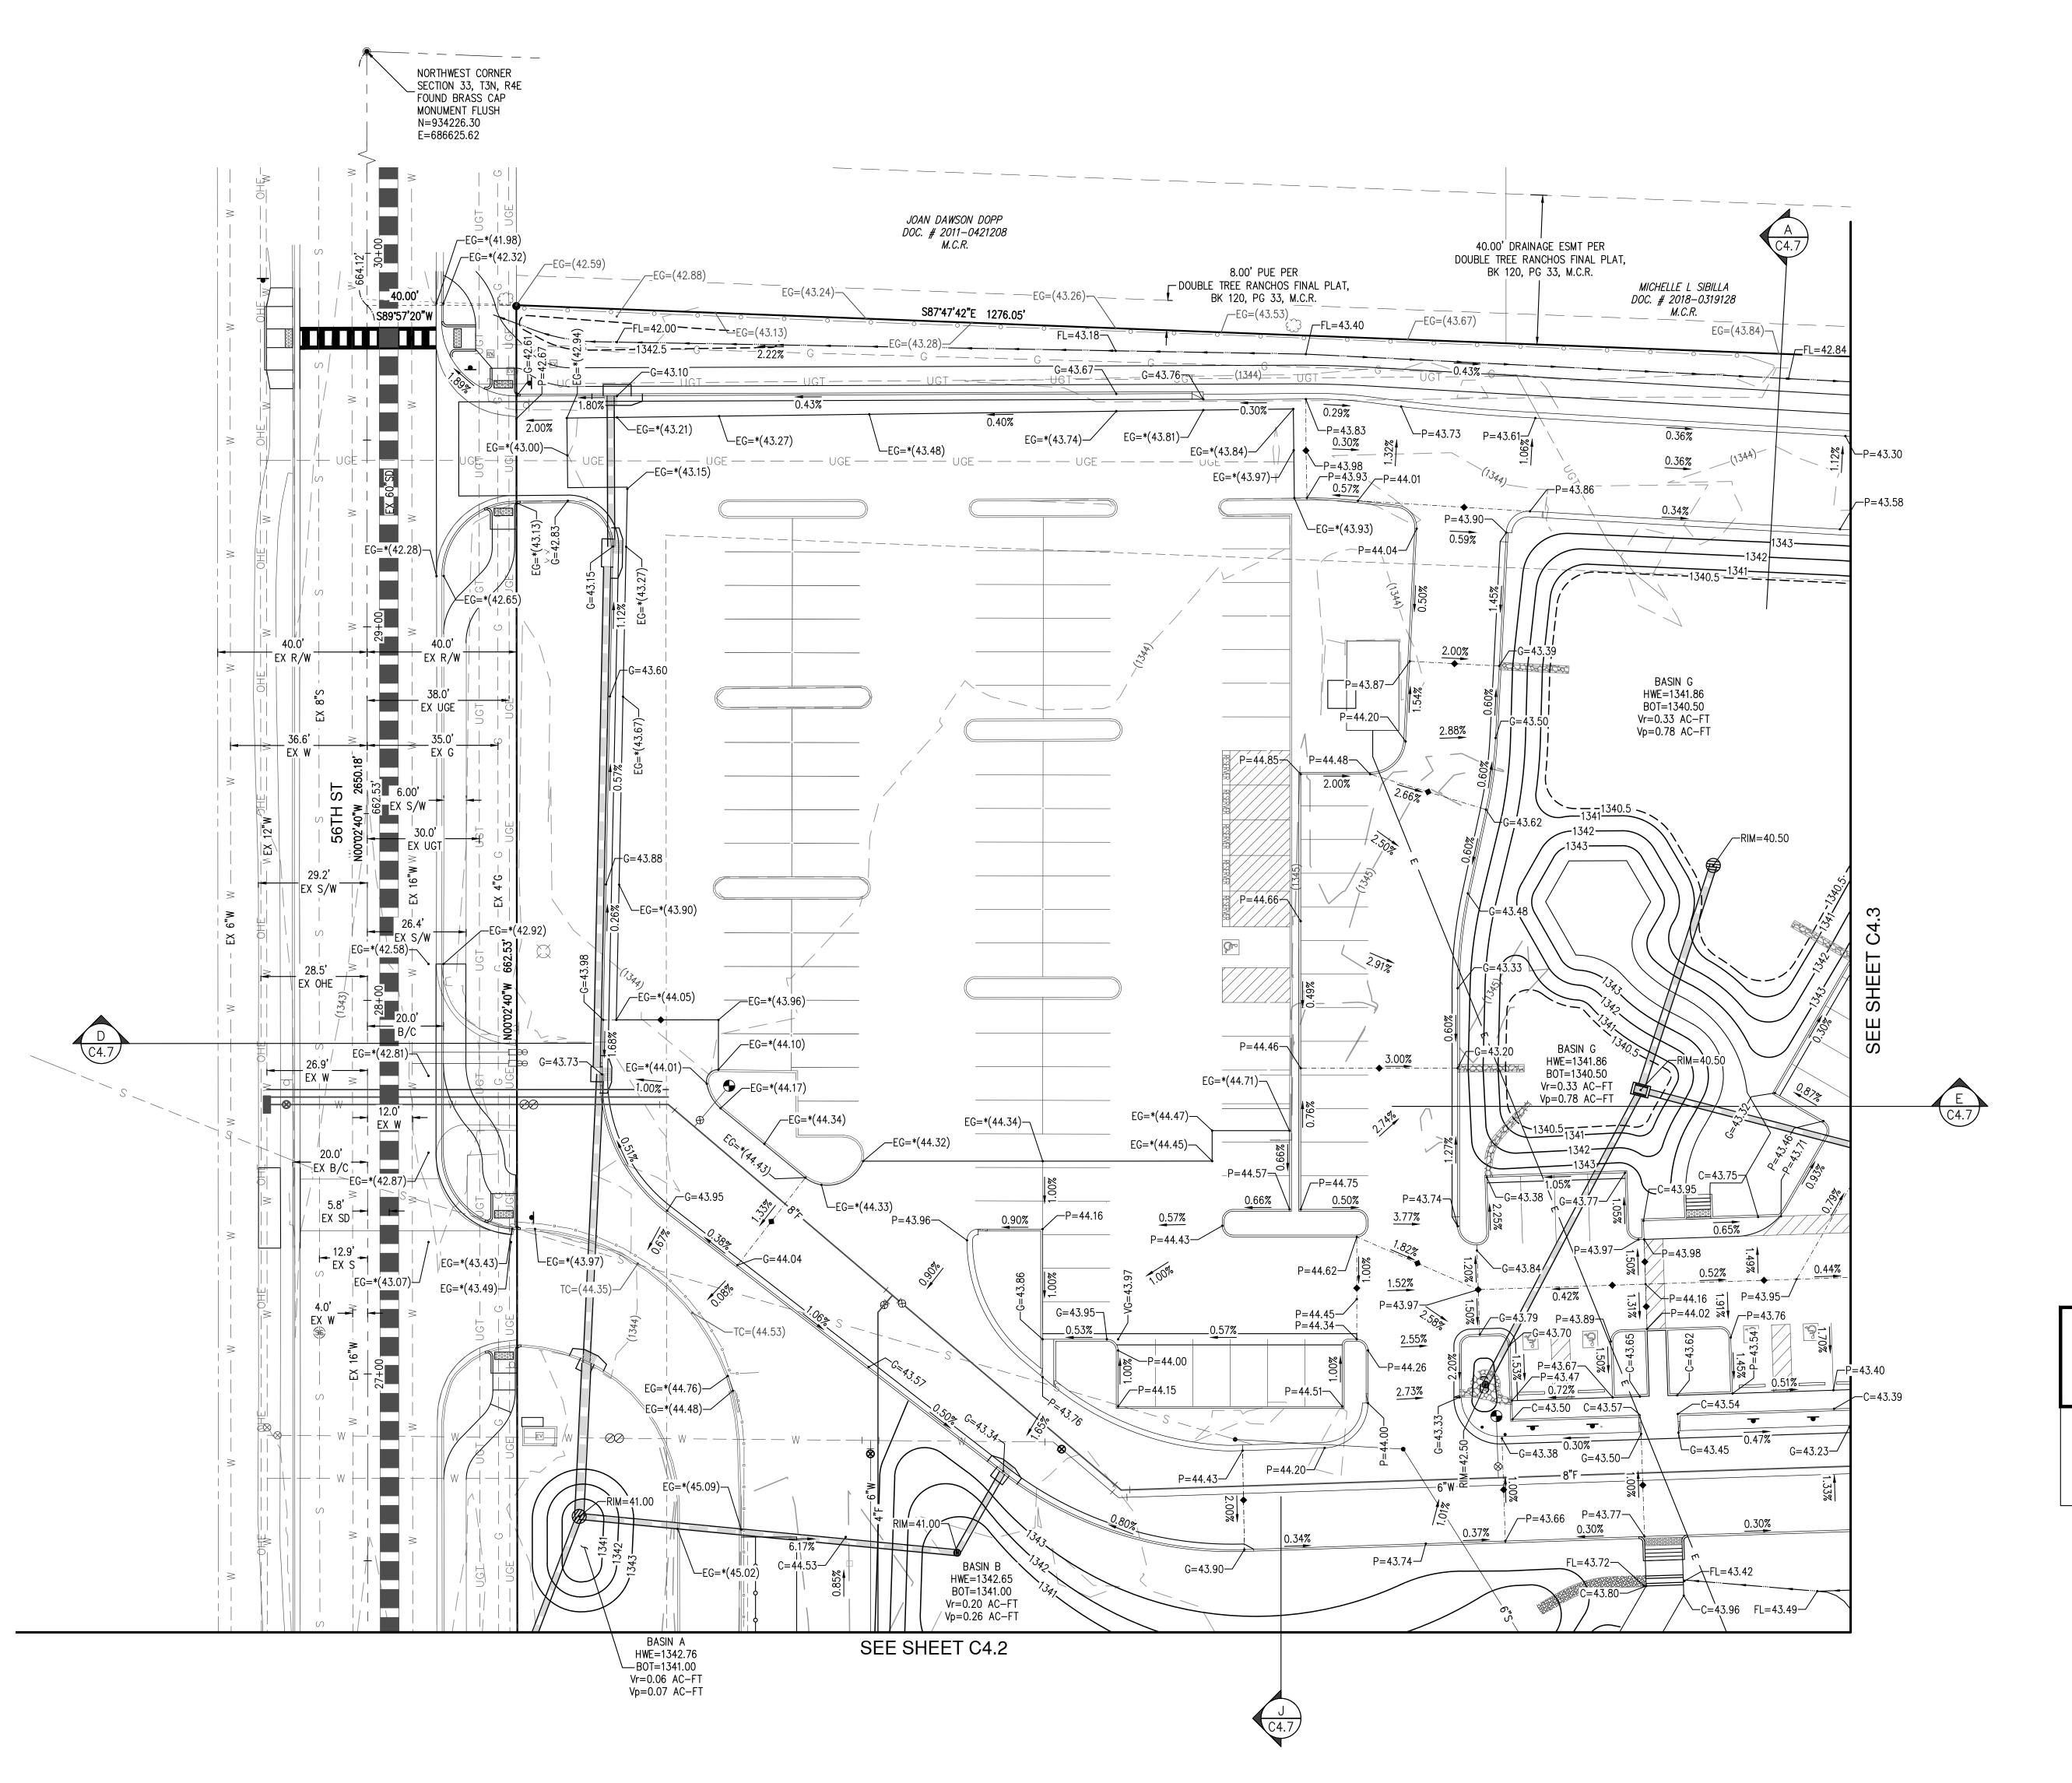
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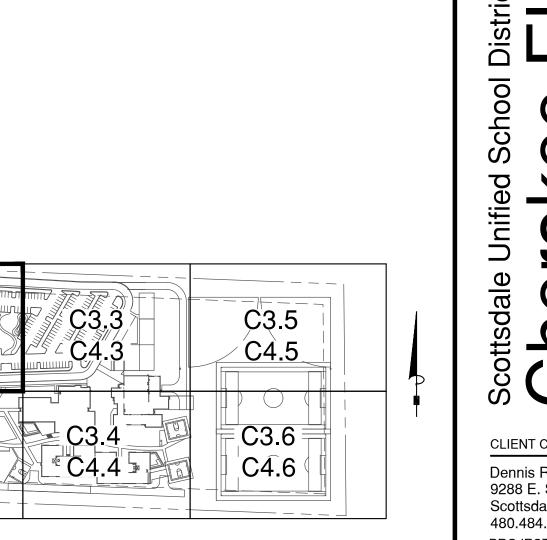
STORM DRAIN

C3.7


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C3.2 C4.2



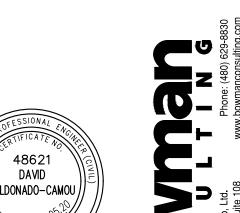

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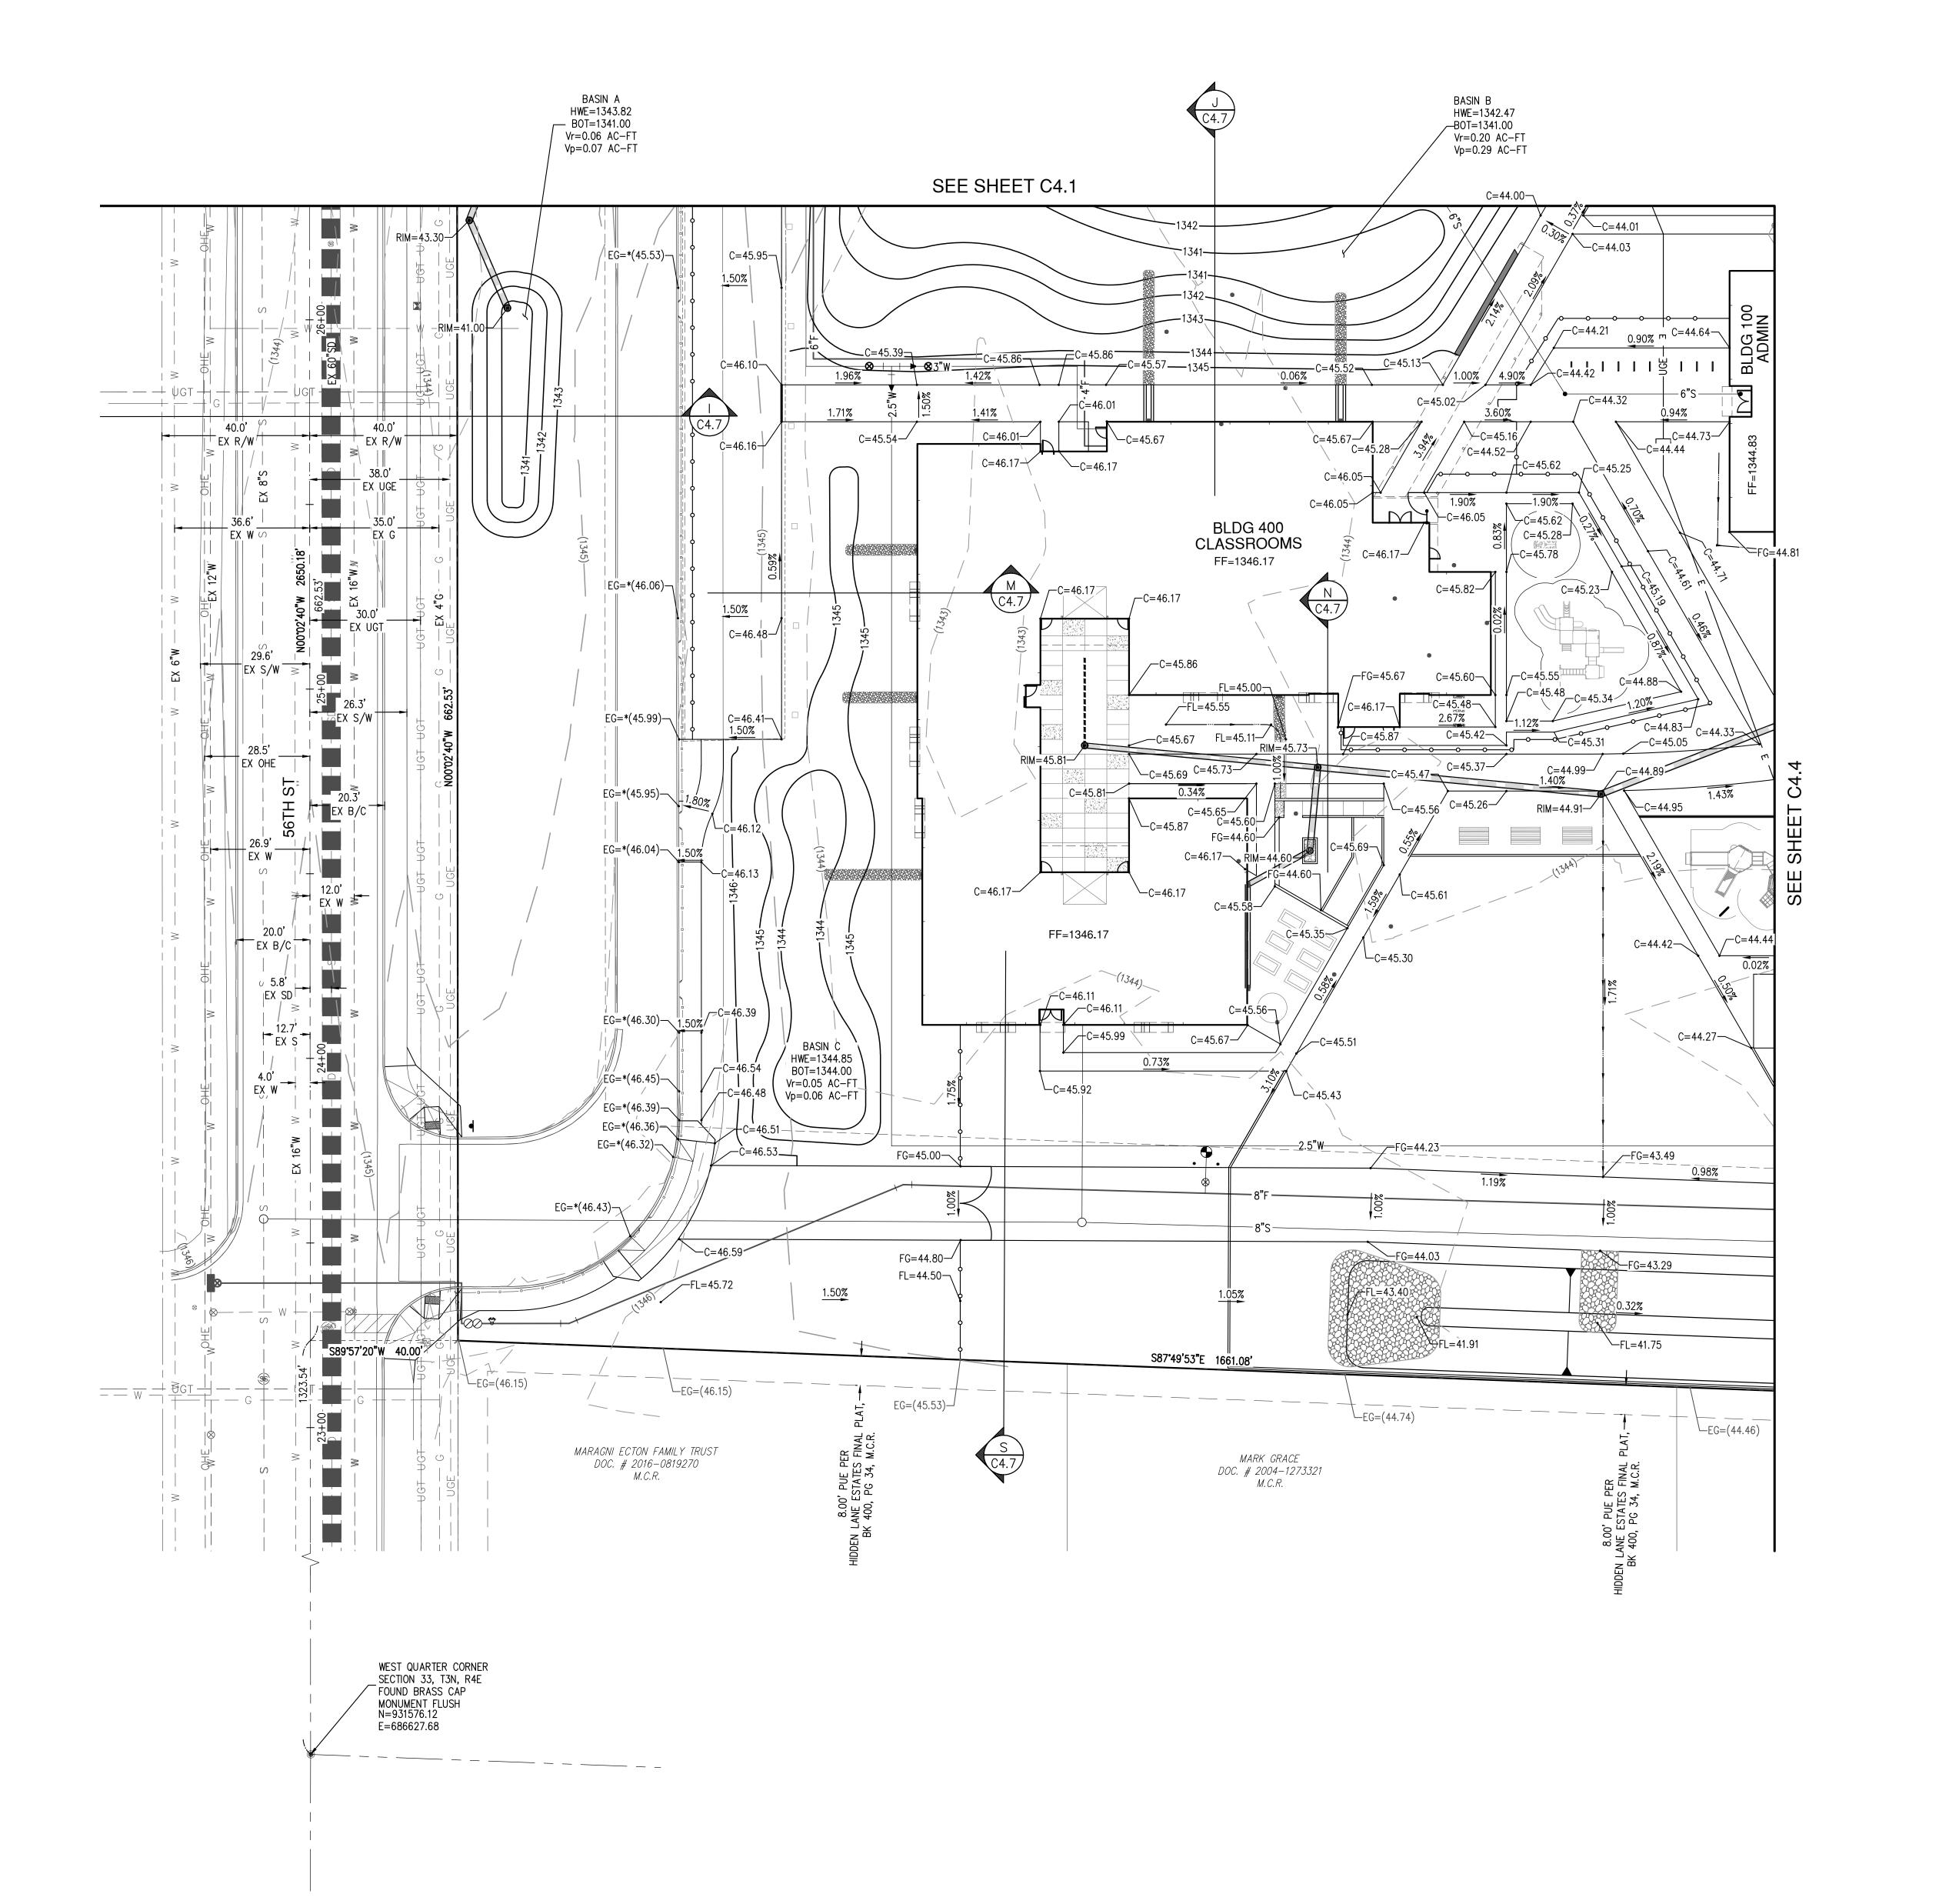
SHEET CONTENTS **GRADING AND** DRAINAGE PLAN


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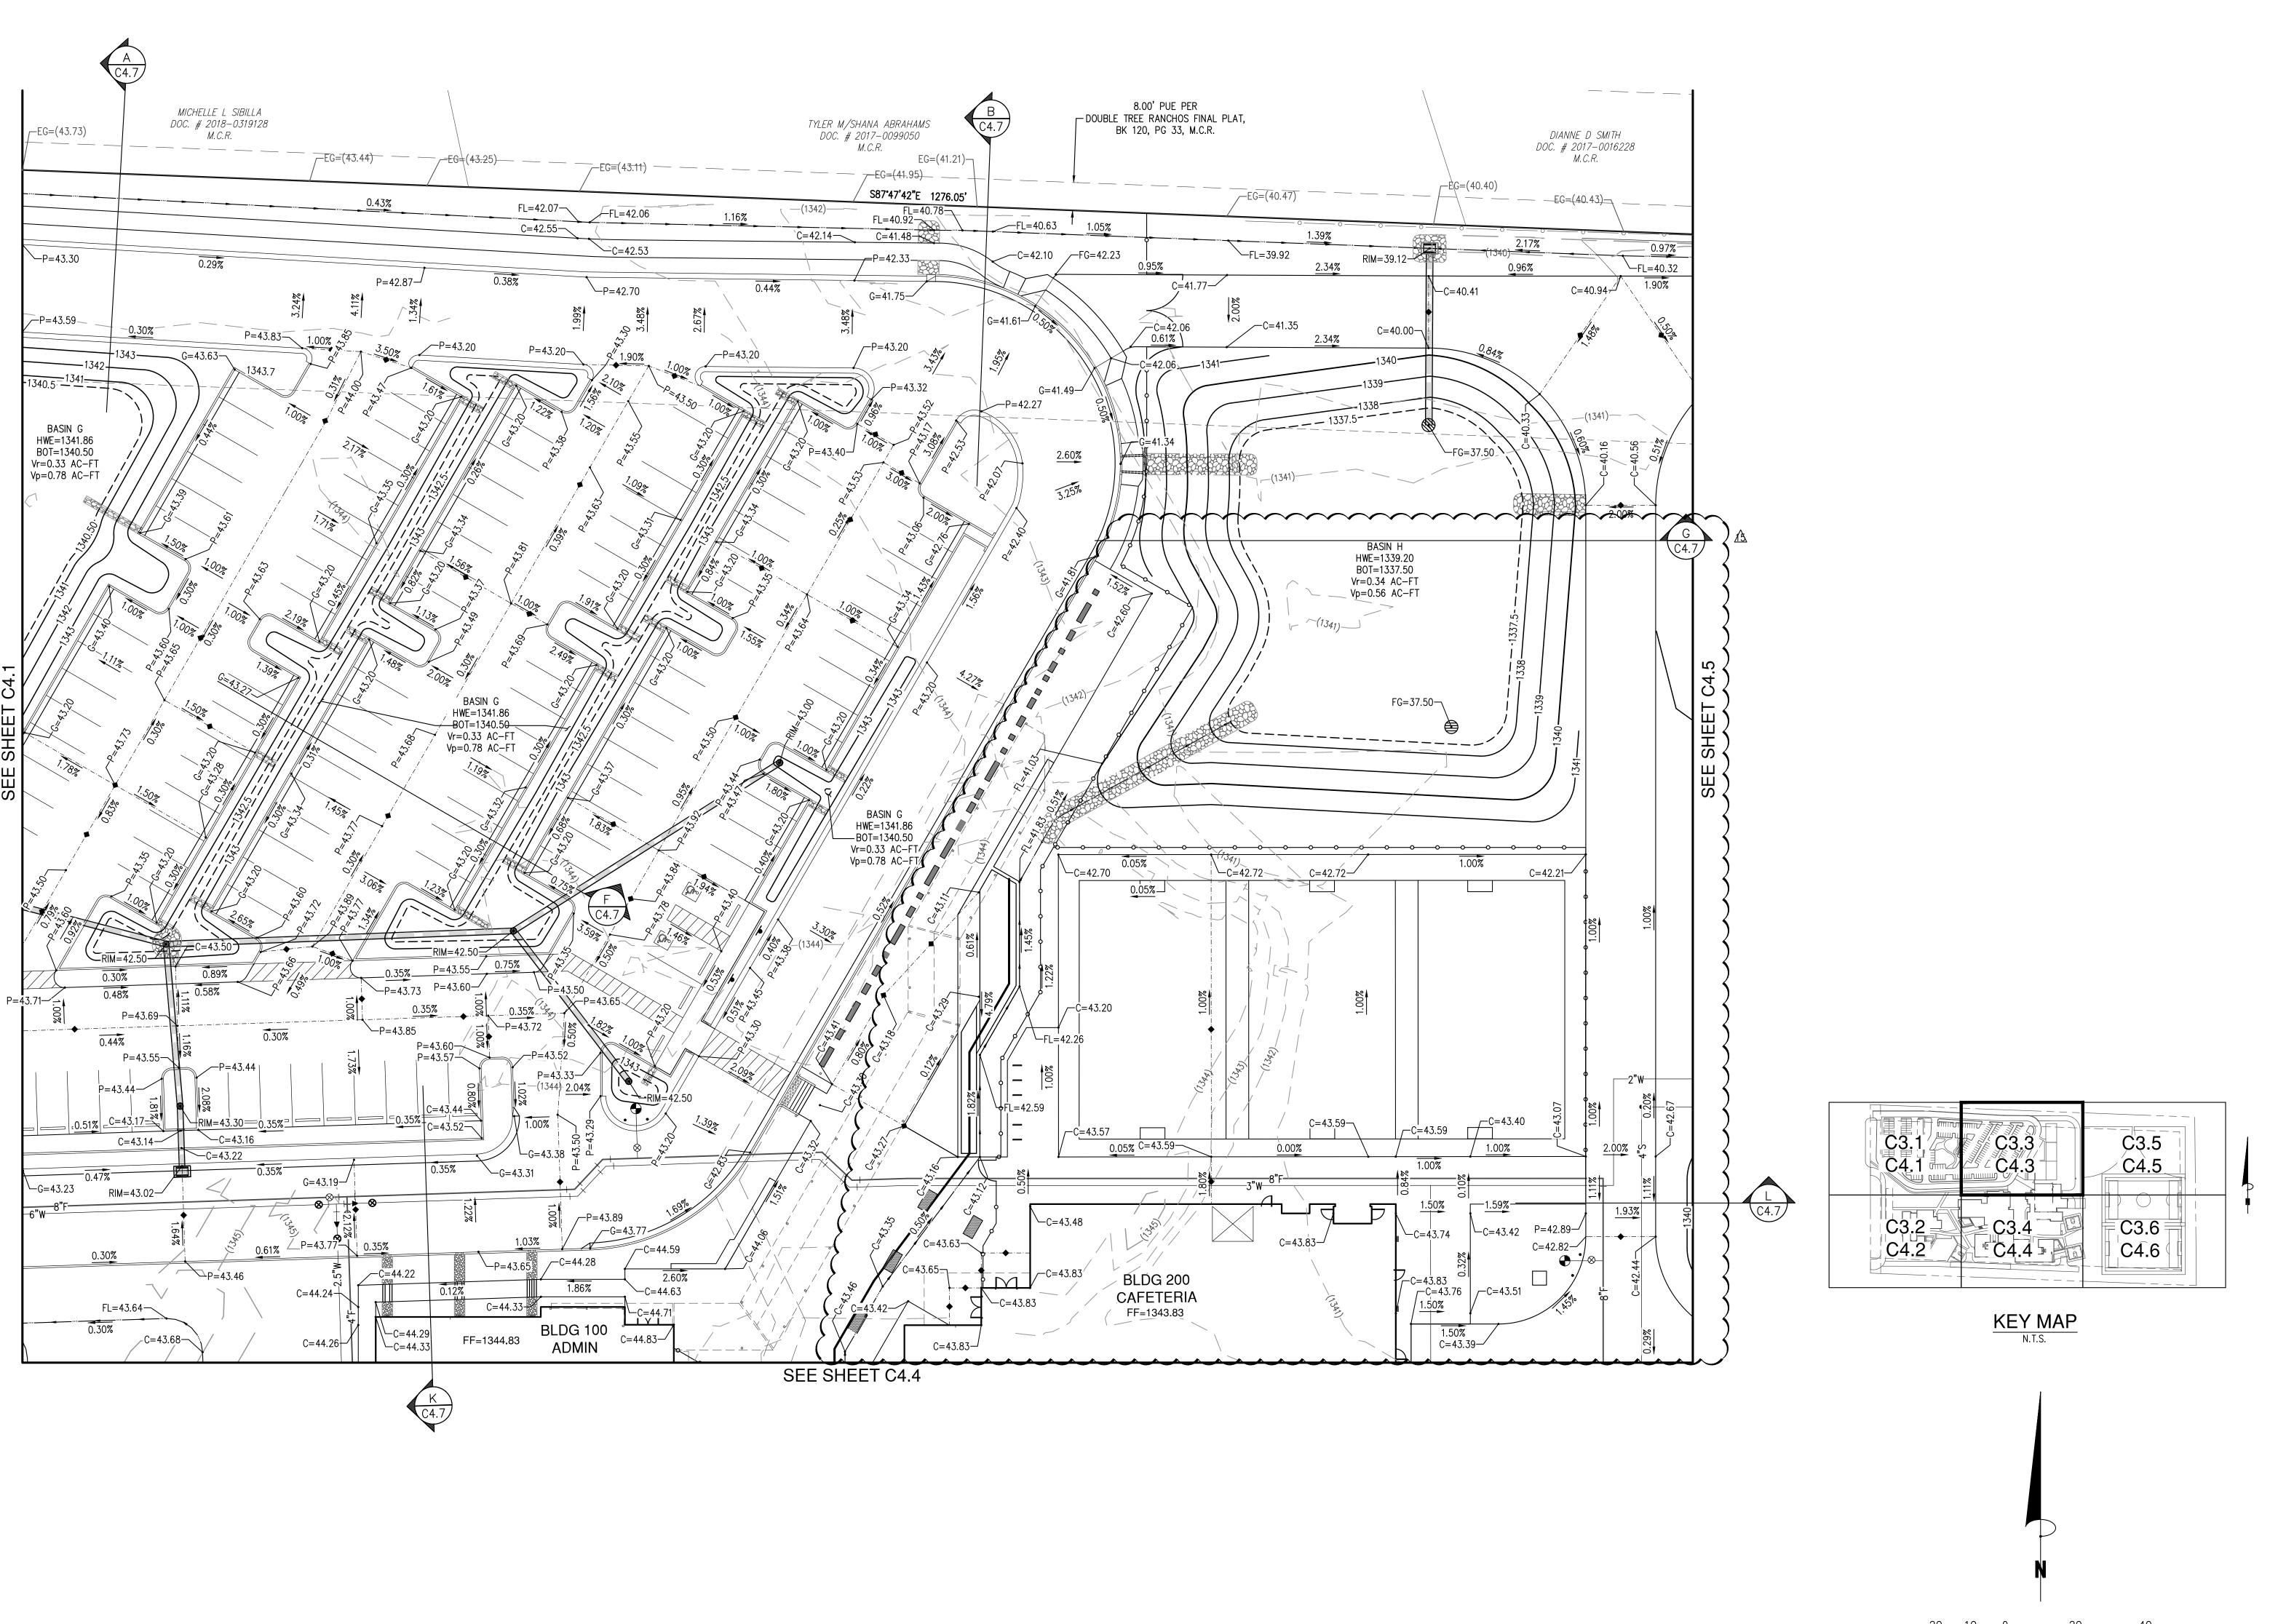
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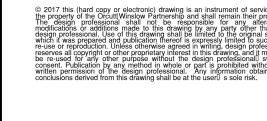
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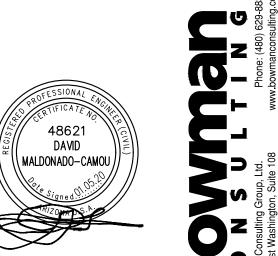
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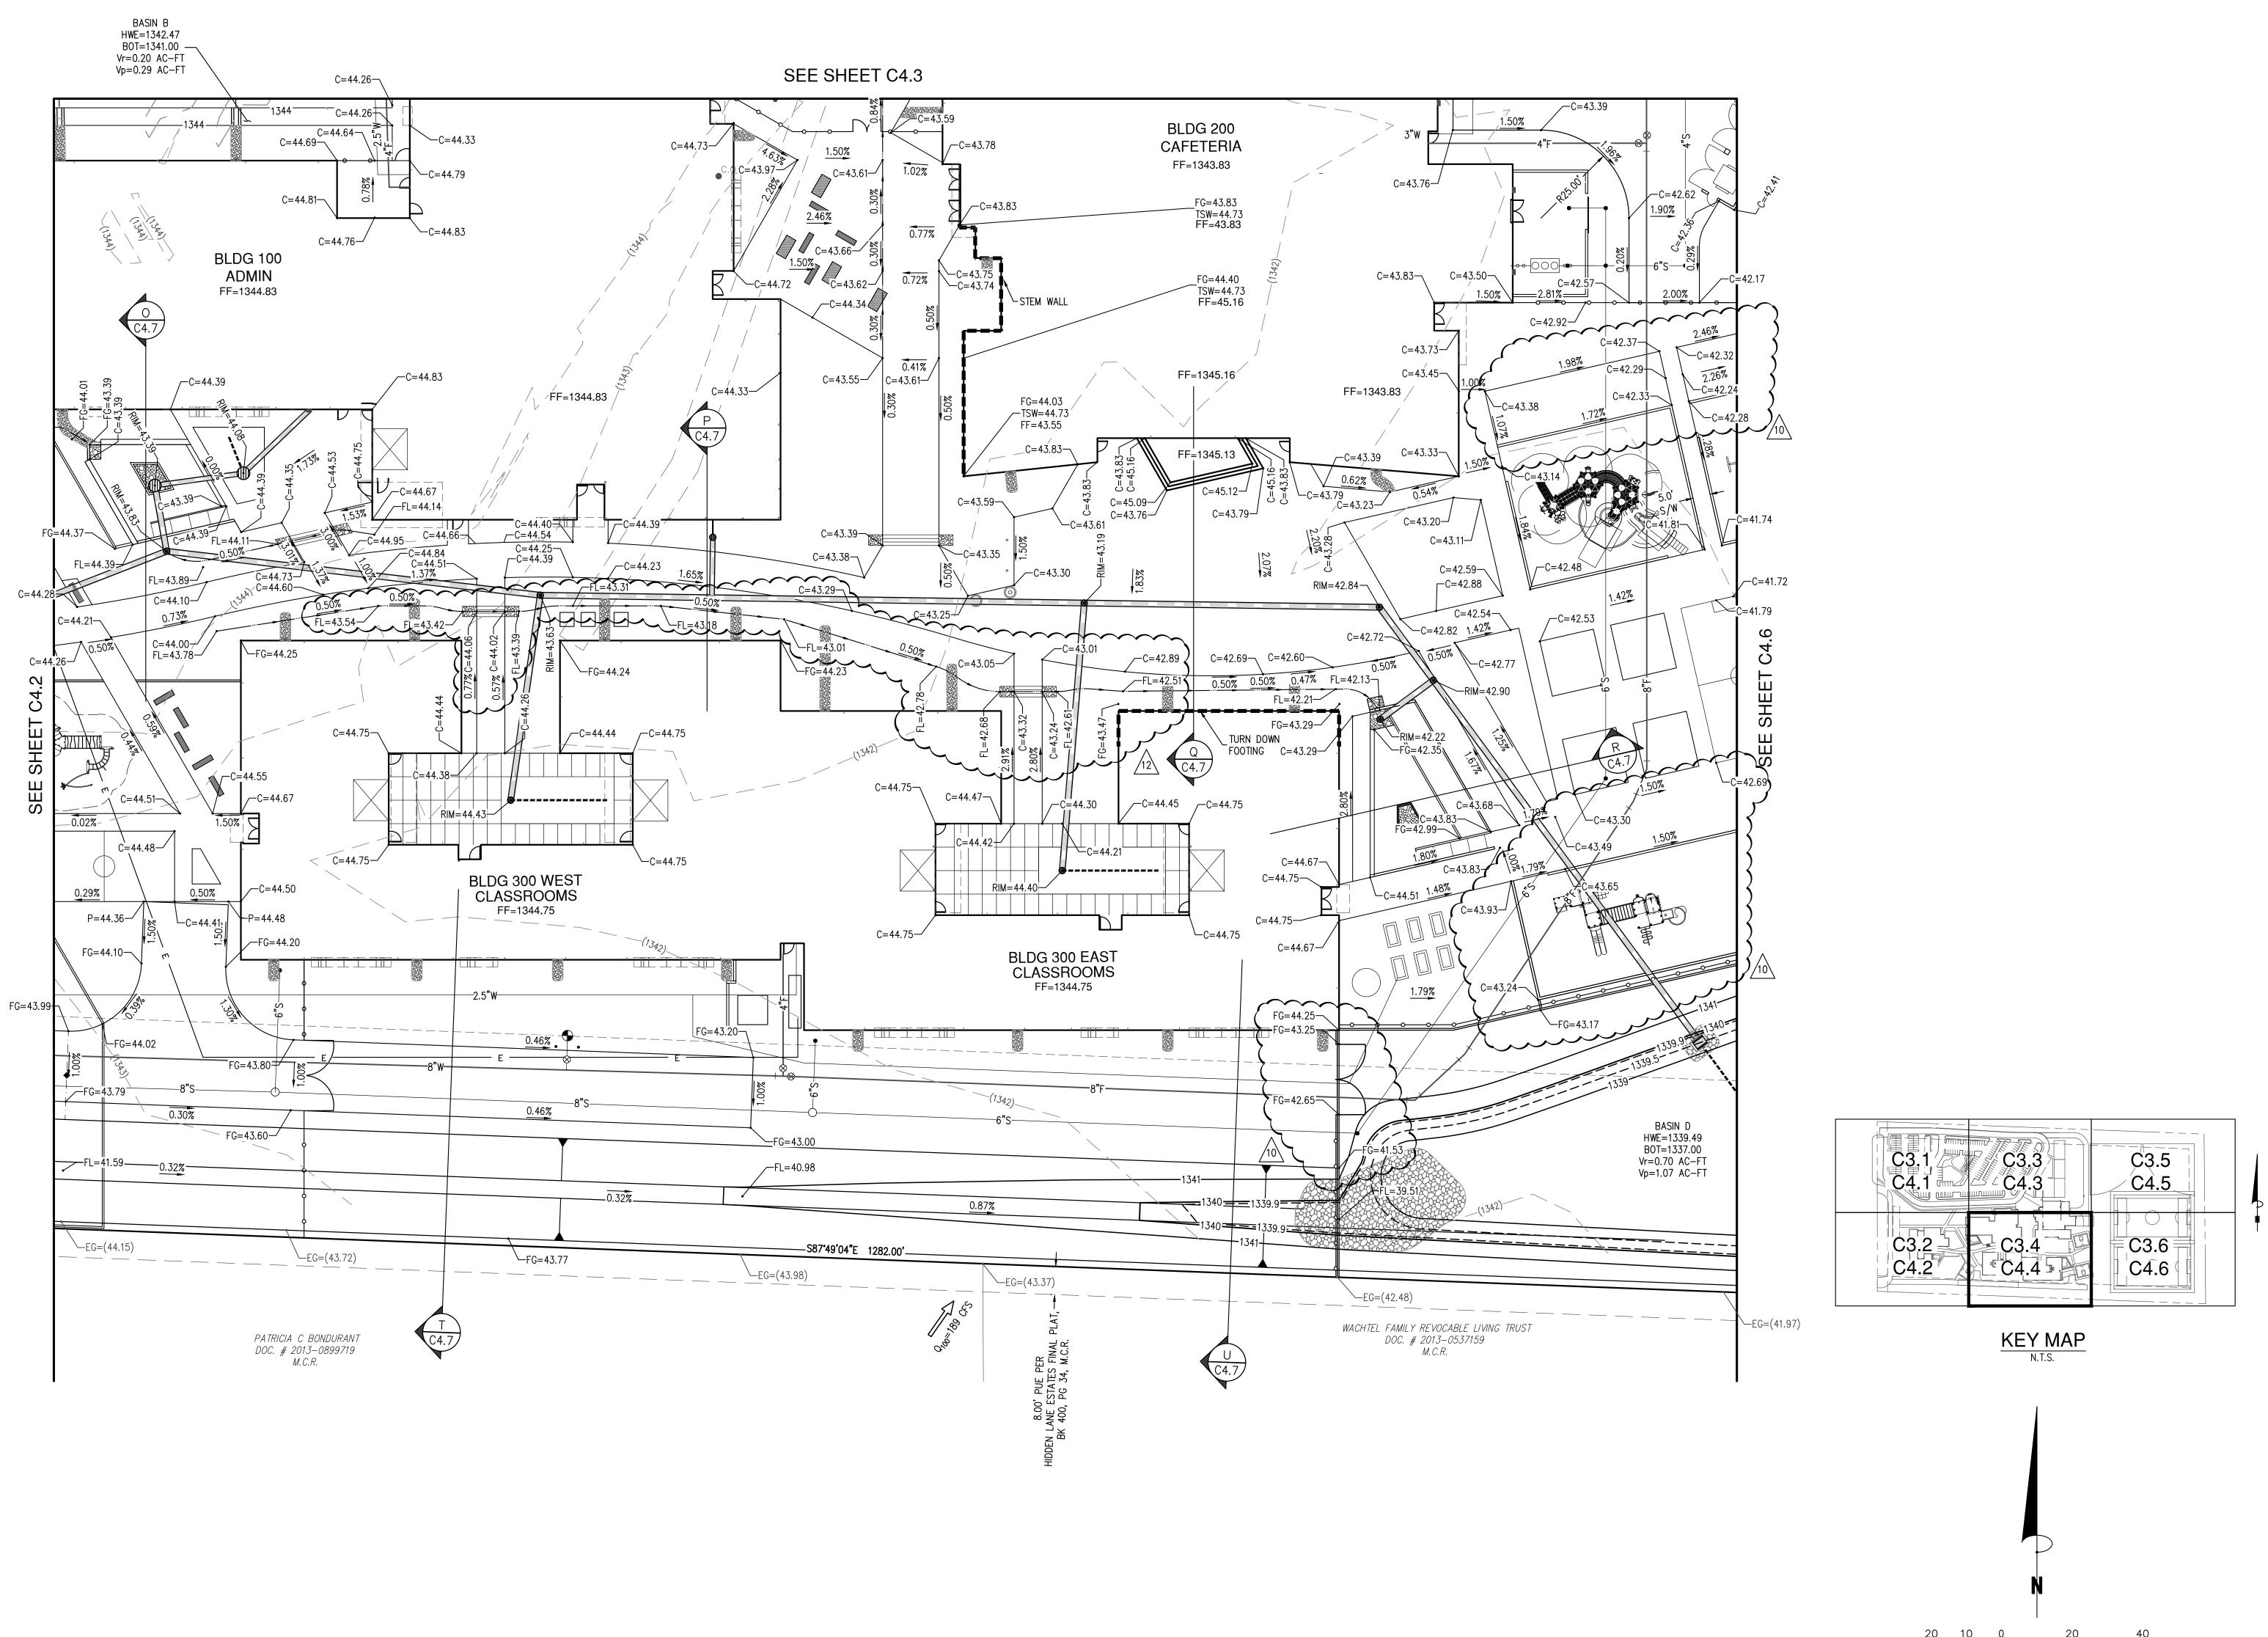
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Call at least two full working days before you begin excavation.
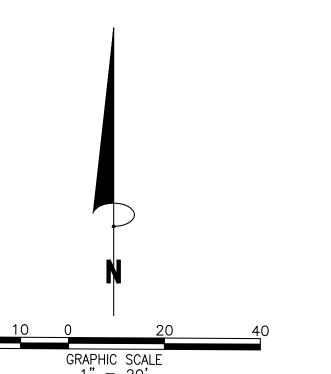
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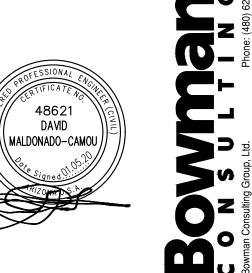
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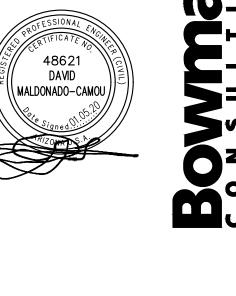
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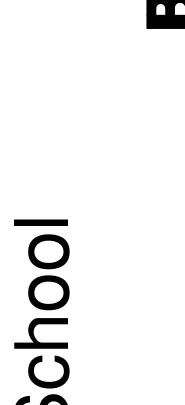
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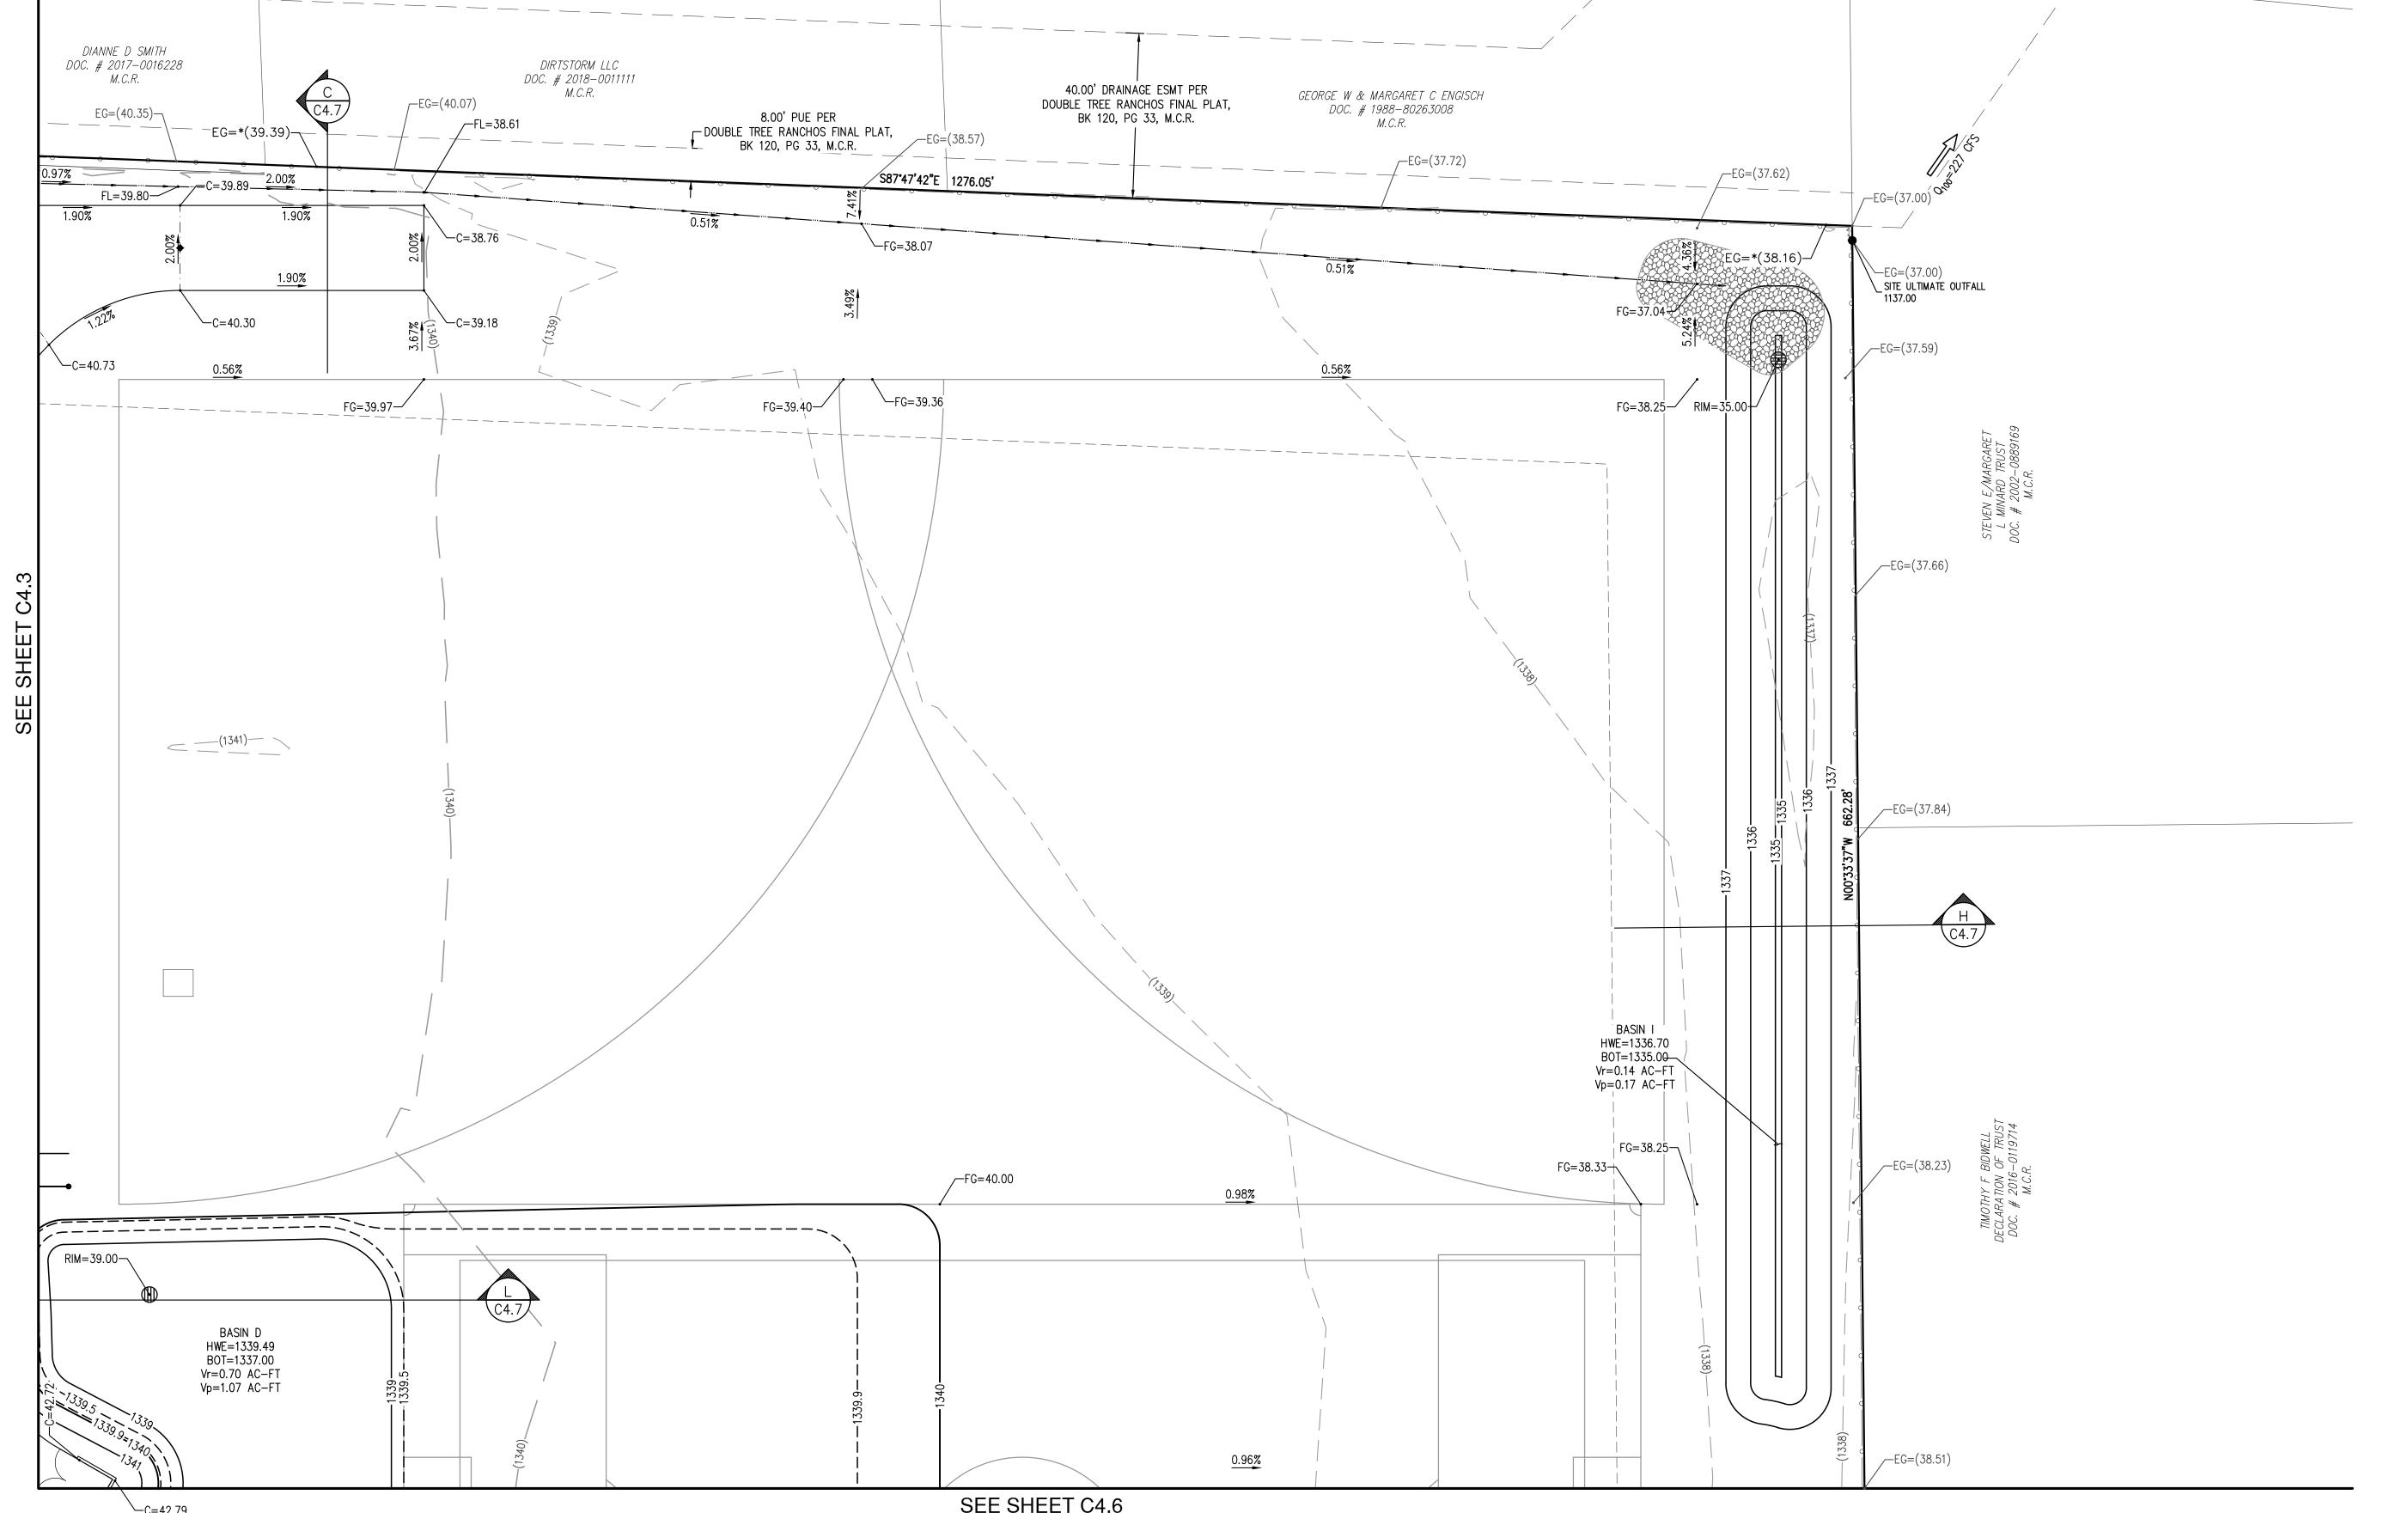
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C3.6 C4.6 KEY MAP

SEE SHEET C4.6

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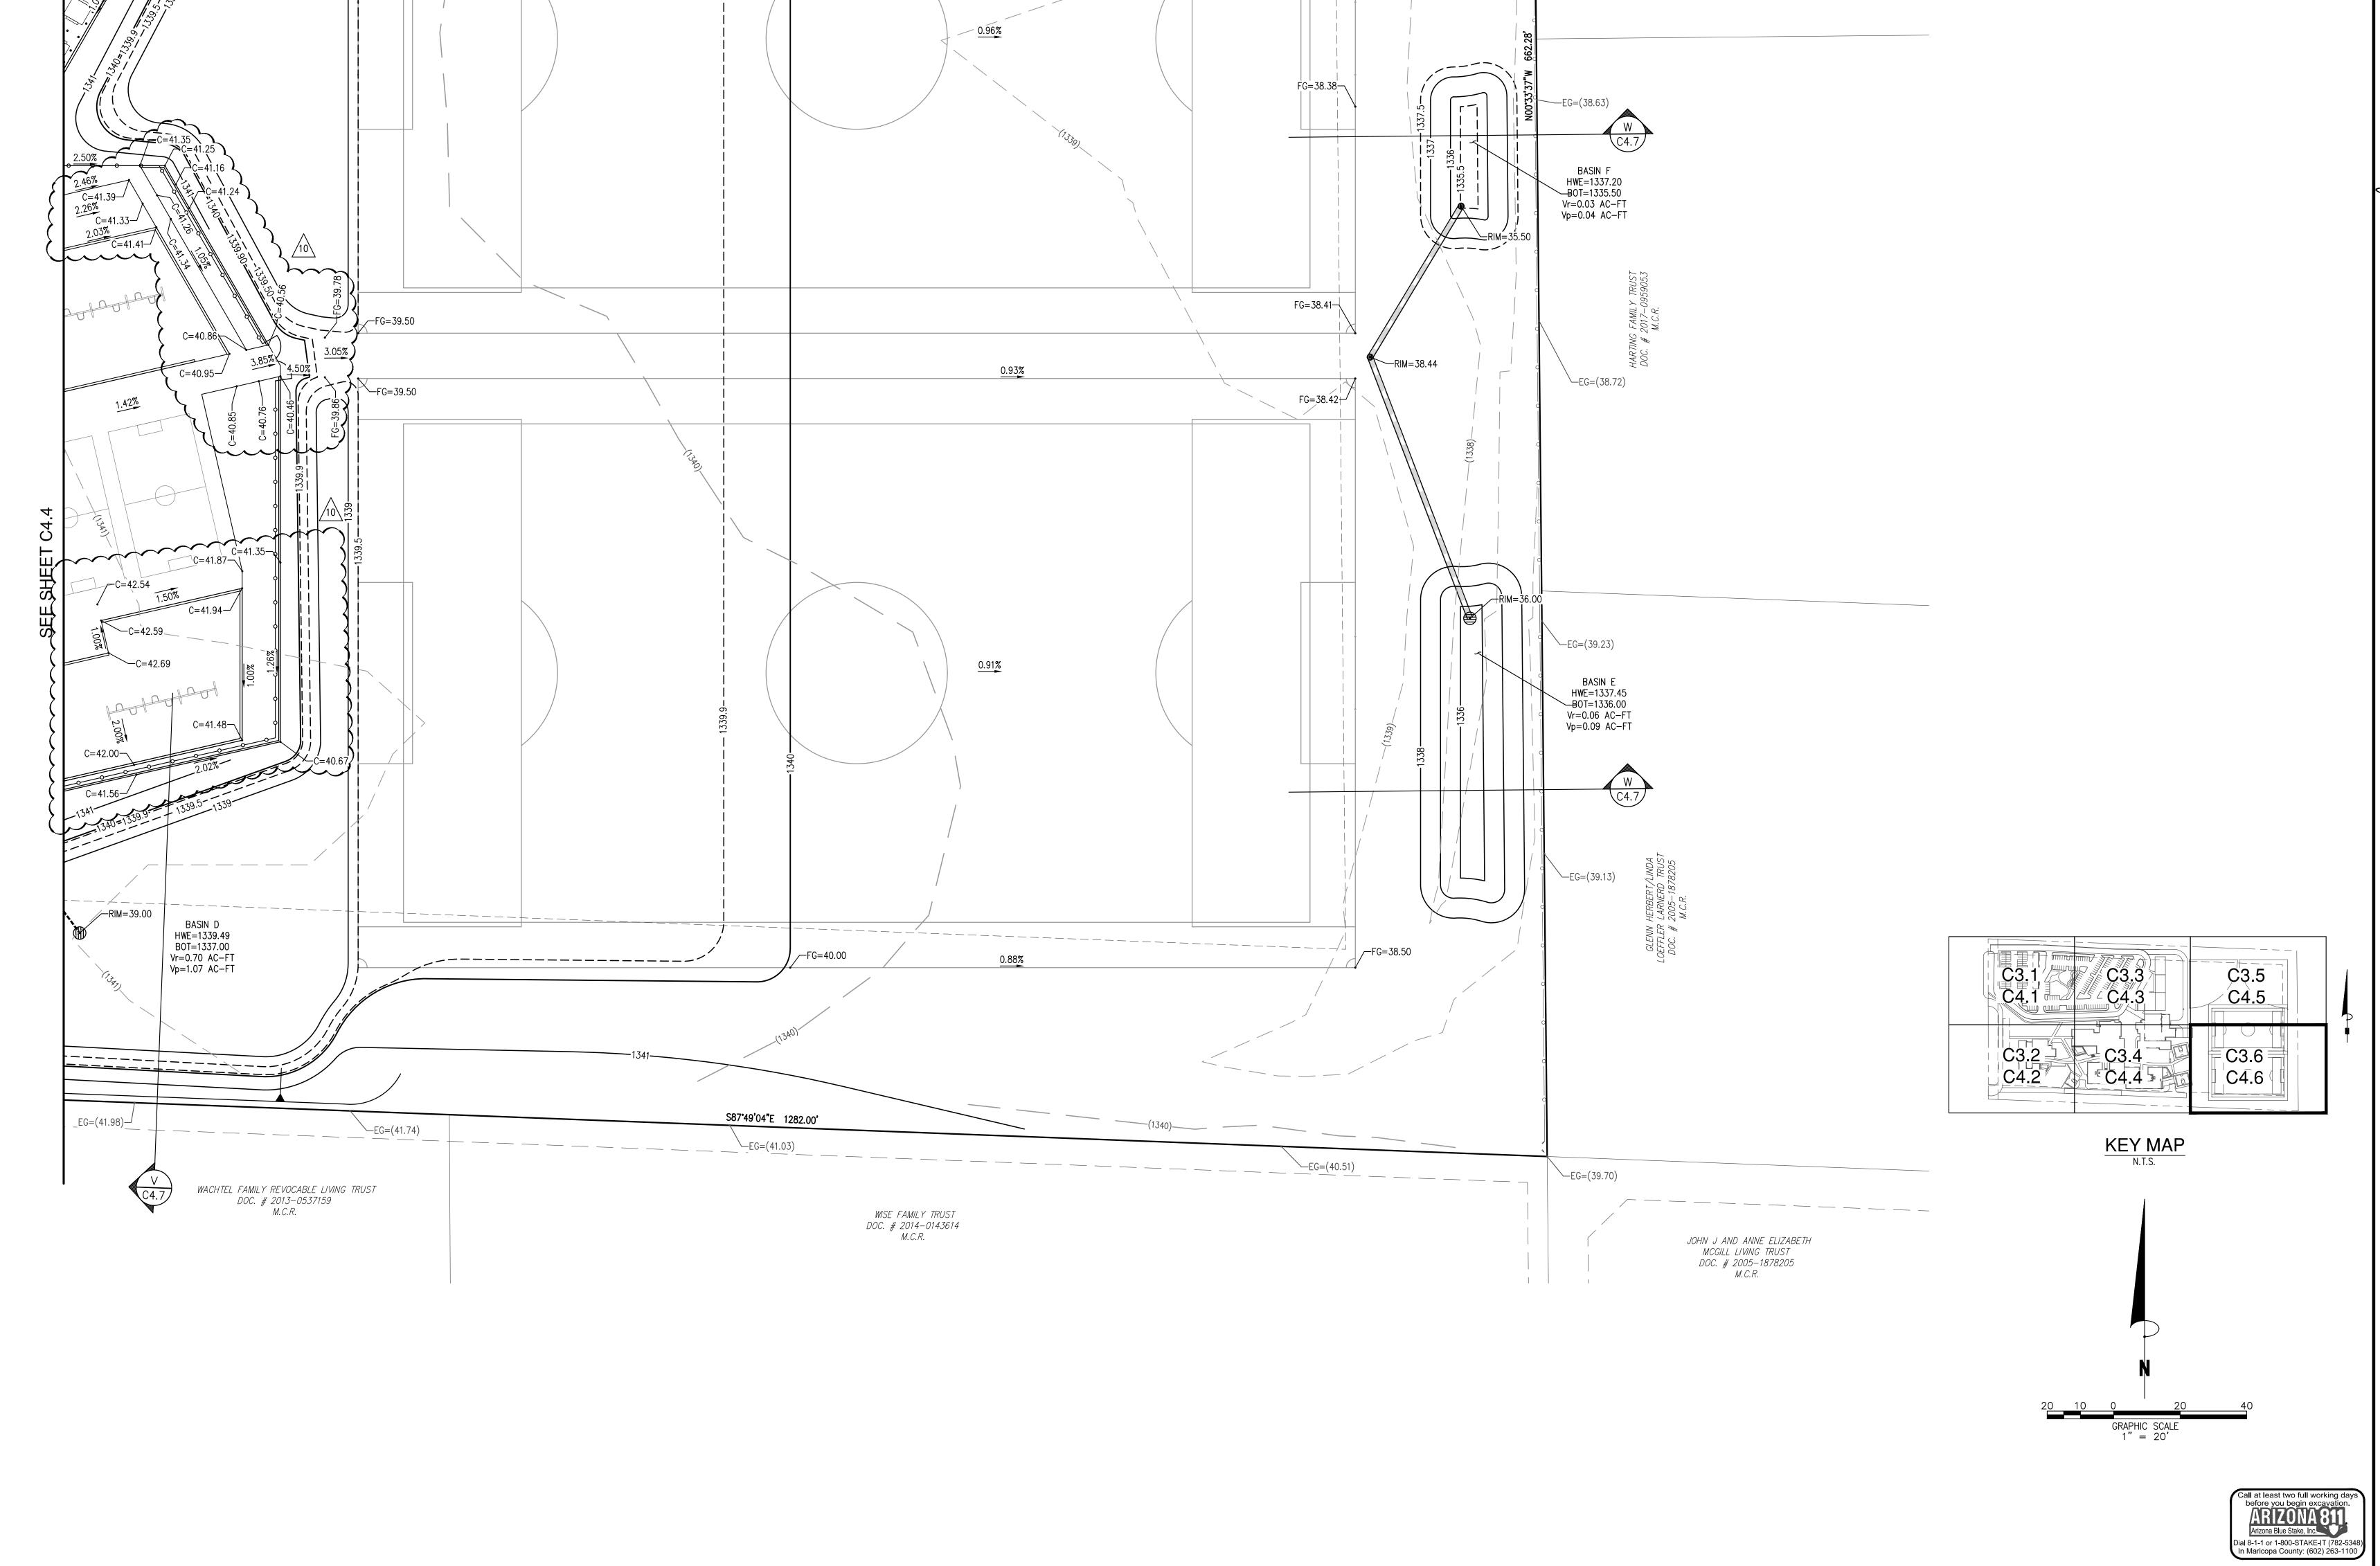
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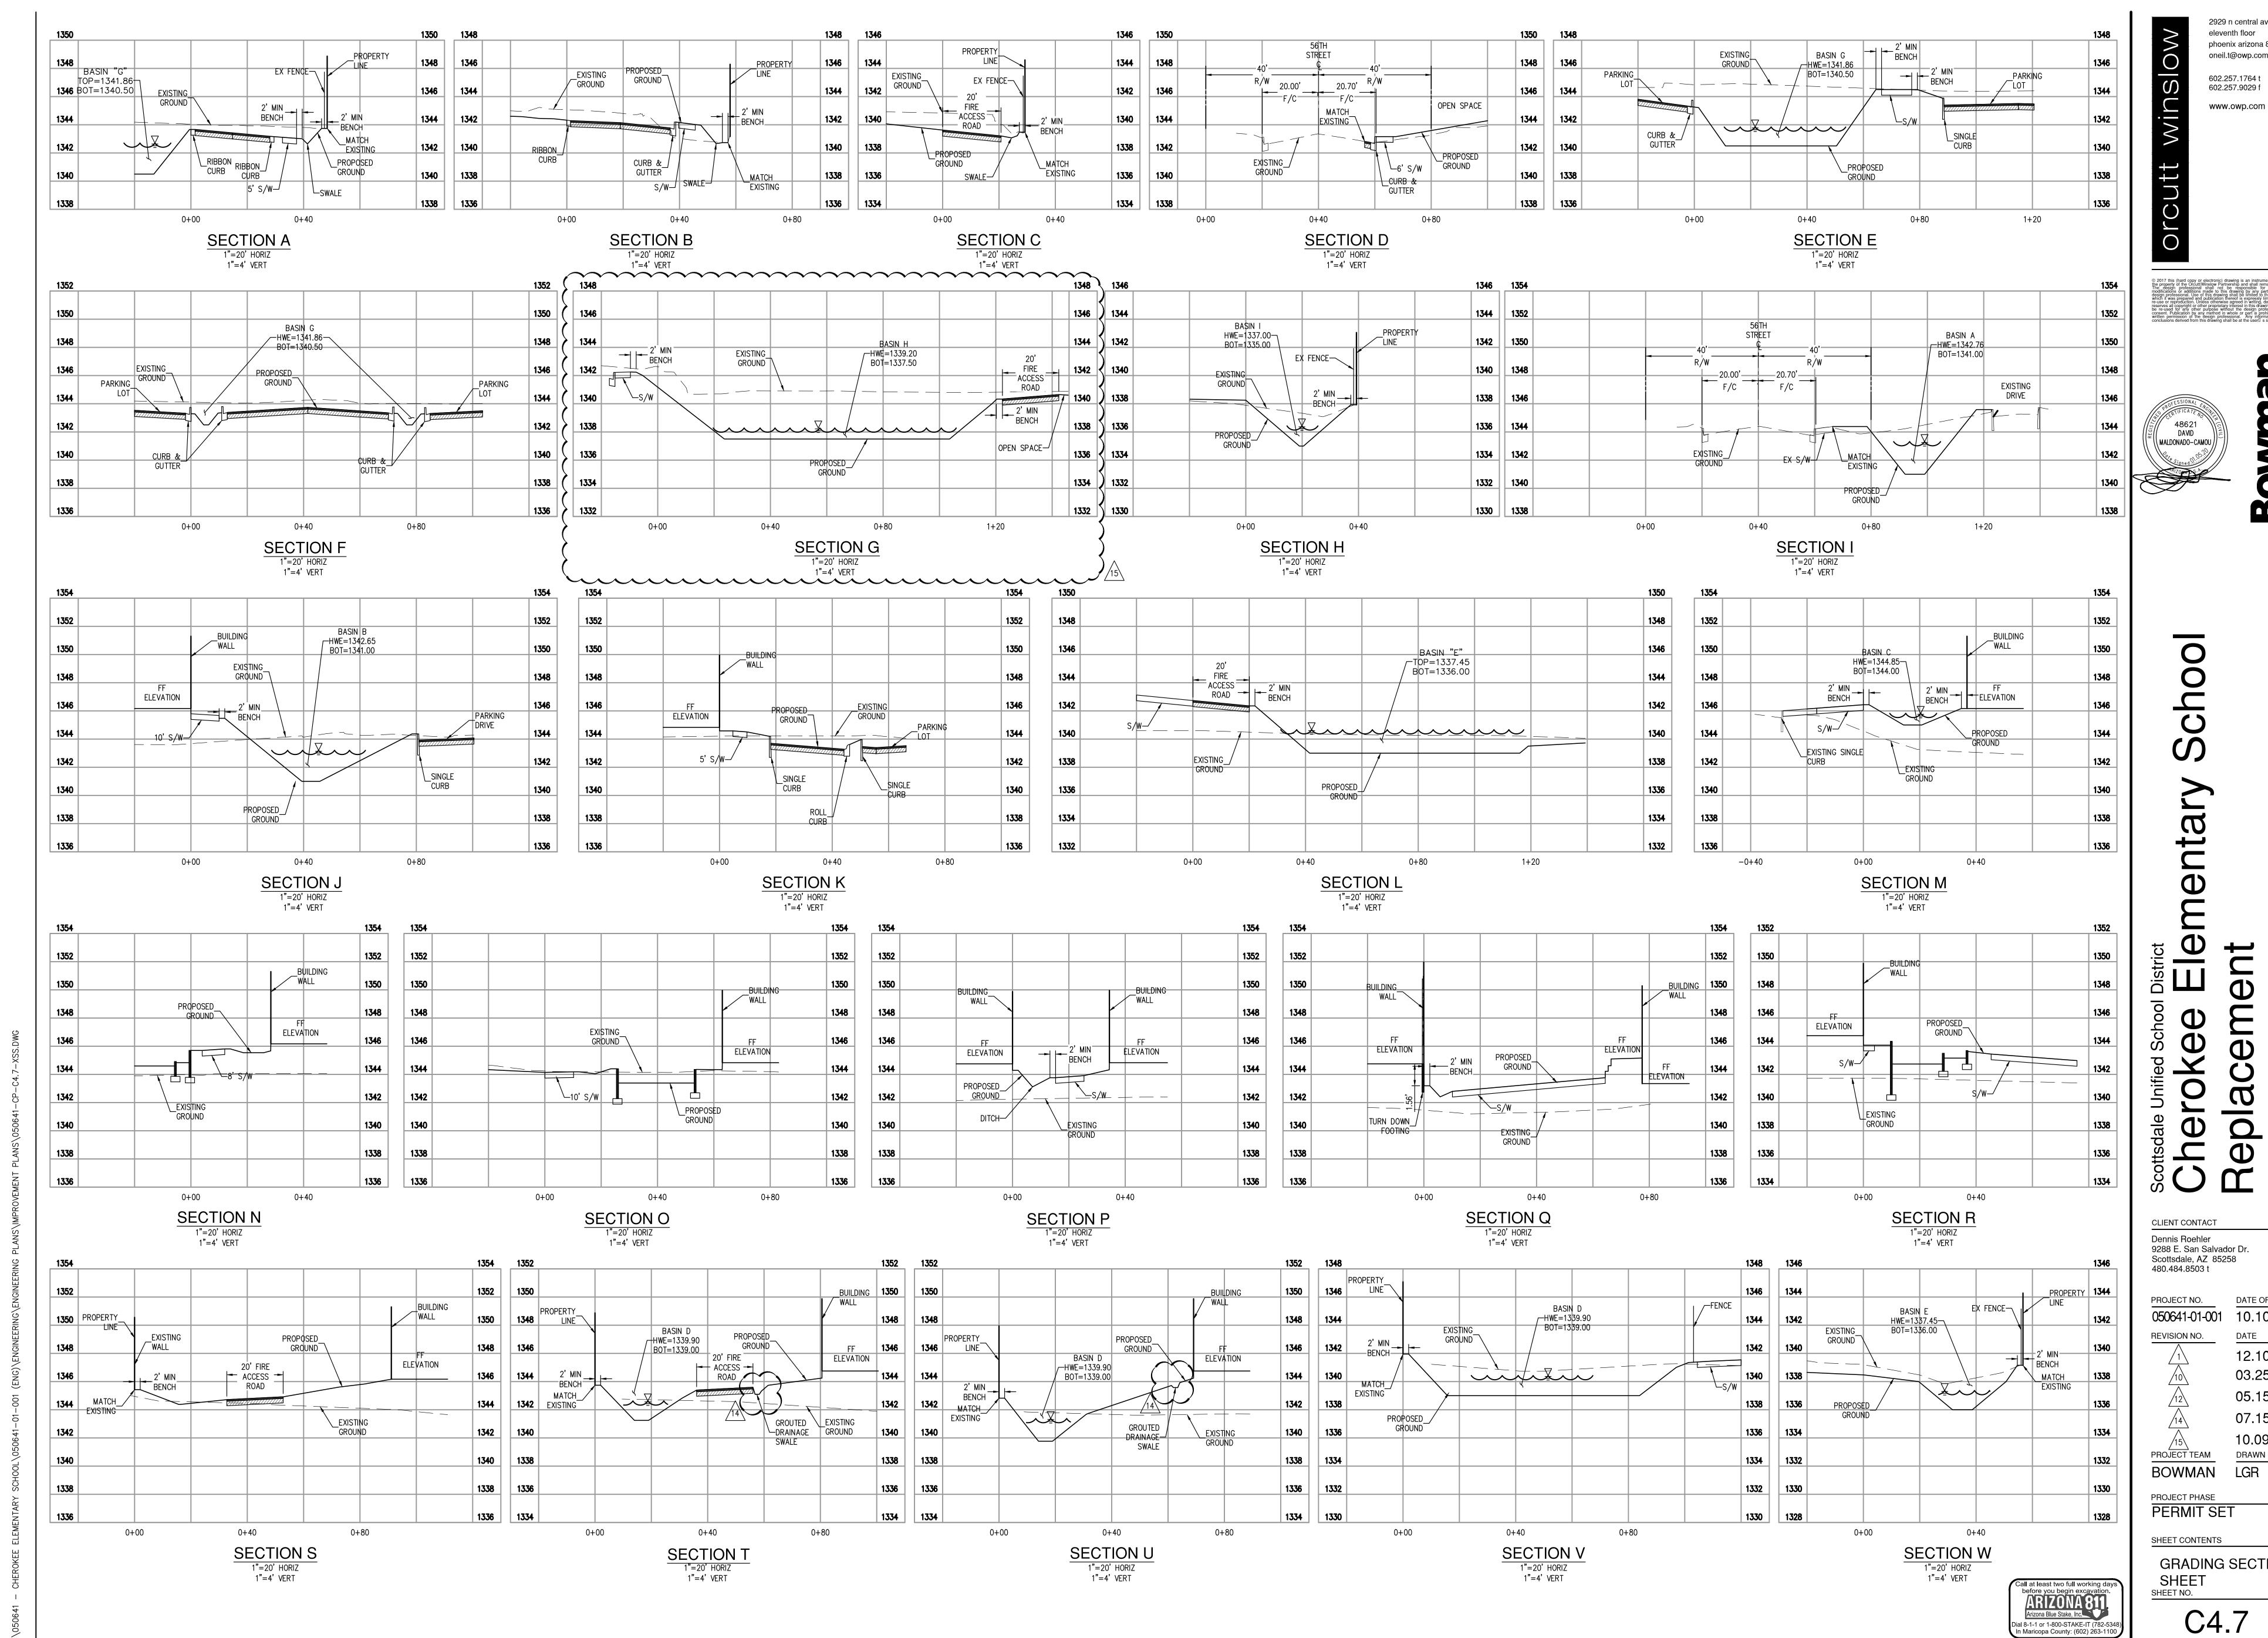
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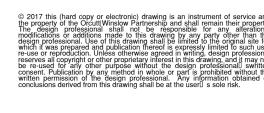
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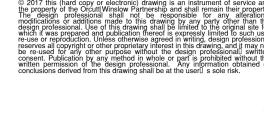


SEE SHEET C4.5

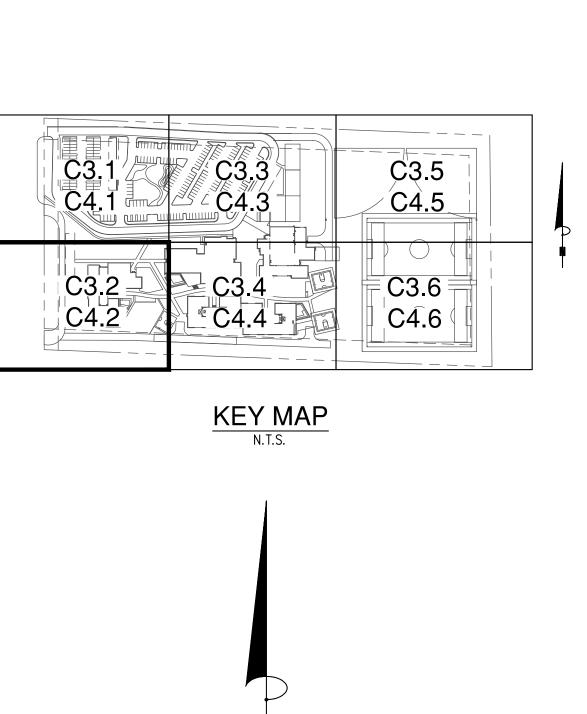


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GRADING SECTIONS

SHT 18 OF 23

Cherokee Elementary School-Paradise Valley, AZ The MaxWell[®] IV Drainage System Detail And Specifications

O NOTES MANHOLE CONE - MODIFIED FLAT BOTTOM. MOISTURE MEMBRANE - 6 MIL. PLASTIC. APPLIES ONLY WHEN NATIVE MATERIAL IS USED FOR BACKFILL. PLACE MEMBRANE SECURELY AGAINST ECCENTRIC CONE AND HOLE SIDEWALL.

- 3. BOLTED RING & GRATE DIAMETER AS SHOWN. CLEAN CAST IRON WITH WORDING "STORM WATER ONLY" IN RAISED LETTERS. BOLTED IN 2 LOCATIONS AND SECURED TO CONE WITH MORTAR. RIM ELEVATION ±0.02' OF PLANS.
- 4. GRADED BASIN OR PAVING (BY OTHERS).
- 5. STABILIZED BACKFILL 1 SACK SLURRY.
- 6. **PUREFLO® DEBRIS SHIELD** ROLLED 16 GA. STEEL X 24" LENGTH WITH VENTED ANTI-SIPHON AND INTERNAL .265" MAX. SWO FLATTENED EXPANDED STEEL SCREEN X 12" LENGTH. FUSION BONDED EPOXY COATED.
- 7. PRE-CAST LINER 4000 PSI CONCRETE 48" ID. X 54" OD. CENTER IN HOLE AND ALIGN SECTIONS TO MAXIMIZE BEARING SURFACE.
- 8. MIN. 6' Ø DRILLED SHAFT.
- 9. SUPPORT BRACKET FORMED 12 GA. STEEL. FUSION BONDED EPOXY COATED.
- 10. OVERFLOW PIPE SCH. 40 PVC MATED TO DRAINAGE PIPE AT BASE SEAL.
- 11. DRAINAGE PIPE ADS HIGHWAY GRADE WITH TRI-A COUPLER. SUSPEND PIPE DURING BACKFILL OPERATIONS TO PREVENT BUCKLING OR BREAKAGE DIAMETER AS NOTED.
- 12. BASE SEAL GEOTEXTILE OR CONCRETE SLURRY.
- 13. ROCK WASHED, SIZED BETWEEN 3/8" AND 1-1/2" TO BEST COMPLEMENT SOIL CONDITIONS.
- 14. FLOFAST® DRAINAGE SCREEN SCH. 40 PVC 0.120" SLOTTED WELL SCREEN WITH 32 SLOTS PER ROW/FT. 120" OVERALL LENGTH WITH TRI-B COUPLER.
- 15. MIN. 4' Ø SHAFT DRILLED TO MAINTAIN PERMEABILITY OF DRAINAGE SOILS.
- 16. FABRIC SEAL U.V. RESISTANT GEOTEXTILE TO BE REMOVED BY CUSTOMER AT PROJECT COMPLETION.
- 17. ABSORBENT HYDROPHOBIC PETROCHEMICAL SPONGE. MIN. 128 OZ. CAPACITY.
- 18. FREEBOARD DEPTH VARIES WITH INLET PIPE ELEVATION. INCREASE SETTLING CHAMBER DEPTH AS NEEDED TO MAINTAIN ALL INLET PIPE ELEVATIONS ABOVE OVERFLOW PIPE INLET.
- 19. INLET PIPE (BY OTHERS).

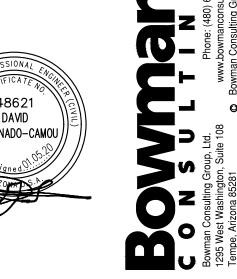INSTALLING ANY DRYWELL OTHER THAN A MAXWELL REQUIRES A SUBMITTAL FOR THE PROJECT ENGINEER'S APPROVAL

(1, 2) INTEGRATED DUCTILE IRON

FRAME & GRATE TO MATCH BASIN O.D.

(3) VARIABLE INVERT HEIGHTS

AVAILABLE (ACCORDING TO

PLANS/TAKE OFF)

(4) VARIOUS TYPES OF INLET & OUTLET ADAPTERS AVAILABLE:

· 24"/30" FOR CORRUGATED HDPE (ADS N-12/HANCOR DUAL WALL,

ADS/HANCOR SINGLE WALL), N-12 HP, PVC SEWER (EX: SDR 35),

PVC DWV (EX: SCH 40), PVC C900/C905, CORRUGATED & RIBBED PVC

. 12" - 30" PEDESTRIAN GRATES SHALL BE DUCTILE

ACCORDING TO PLAN DETAILS. RISERS ARE NEEDED

RESTRICTIONS. SEE DRAWING NO. 7001-110-065.

. DRAINAGE CONNECTION STUB JOINT TIGHTNESS SHALL

CONFORM TO ASTM D3212 FOR CORRUGATED HDPE

(ADS N-12/HANCOR DUAL WALL), N-12 HP, & PVC


IRON PER ASTM A536 GRADE 70-50-05.

FOR BASINS OVER 84" DUE TO SHIPPING

. DRAIN BASIN TO BE CUSTOM MANUFACTURED

A536 GRADE 70-50-05.

SEWER (4" - 24").

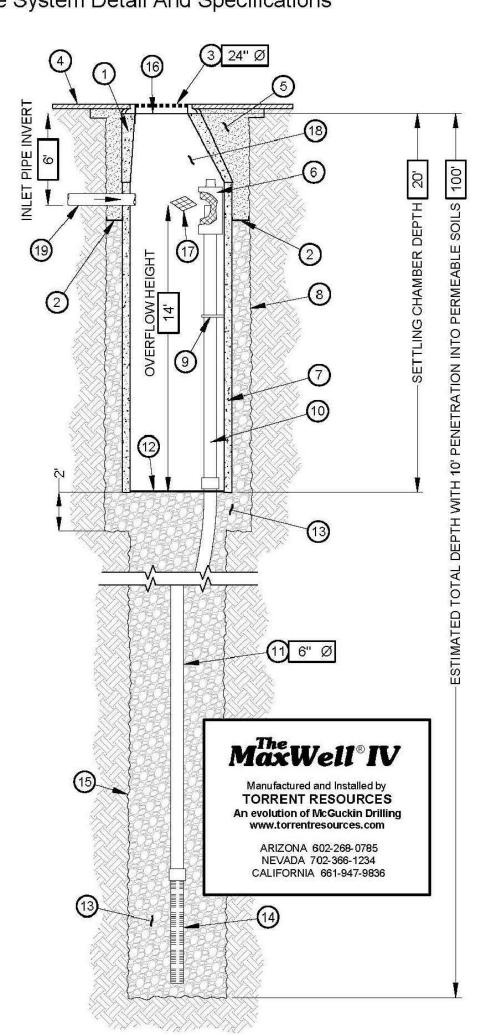

AZ Lic. ROC070465 A, ROC047067 B-4, ADWR 363

NVLic 0035350 A - NMLic 90504 GE04 U.S. Patent No. 4,923,330 - TM Trademark 1974, 1990, 2004

NYLOPLAST 24"/30" DRAIN BASIN

(5) ADAPTER

ANGLES

VARIABLE 0°

THIS PRINT DISCLOSES SUBJECT MATTER IN WHICH | DRAWN BY EBC | MATERIAL

REVISED BYNMH | PROJECT NO./NAME

NYLOPLAST INLET PER PLAN-

MINIMUM PIPE BURIAL

DEPTH PER PIPE

MANUFACTURER

(MIN. MANUFACTURING

REQ. SAME AS MIN. SUMP)

(6" MIN. ON 12" - 24",

10" MIN. ON 30")

WATERTIGHT JOINT

INSTALL NYLOPLAST SUMP, INSERT

2. 12" - 30" FRAMES SHALL BE DUCTILE IRON PER ASTM DRAWING NO. 7001-110-144 FOR H-20 TRAFFIC LOAD GUIDELINES).

ACCESSORY TO ELIMINATE BASIN A

SUMP PER MANUFACTURER

SPECIFICATIONS

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TRANSFER, OR LICENSE THE USE OF THE DESIGN OR

(CORRUGATED HDPE SHOWN)

RECOMMENDATION

C2013 NYLOPLAST DWG SIZE A SCALE 1:40 SHEET 1 OF 1 DWG NO. PERMISSION FROM NYLOPLAST. NYLOPLAST - ENGINEERED SURFACE DRAINAGE PRODUCTS

- WEIR AVAILABLE FOR ALL 24" - 30" STRUCTURE OPTIONS (CUSTOM BASIN,

DRAIN BASIN TO BE CUSTOM MANUFACTURED ACCORDING TO PLAN DETAILS.

3 - HEIGHT OF WEIR TO BE DETERMINED BY ENGINEER. WEIR HEIGHT CANNOT

EXCEED 84" DUE TO MANUFACTURING AND SHIPPING RESTRICTIONS.

WEIR MANUFACTURED TO MINIMIZE LOSS OF OUTLET PIPE OPEN AREA.

5 - ADAPTERS CAN BE MOUNTED ON ANY ANGLE 0° TO 360°. TO DETERMINE

MINIMUM ANGLE BETWEEN ADAPTERS SEE DRAWING NO. 7001-110-012.

ASTM D3212 FOR CORRUGATED HDPE (ADS N-12/HANCOR DUAL WALL),

- FRAMES, GRATES, COVERS, HOODS, & BASE PLATES SHALL BE DUCTILE IRON

- DRAINAGE CONNECTION STUB JOINT TIGHTNESS SHALL CONFORM TO

RISERS ARE NEEDED FOR BASINS OVER 84" DUE TO SHIPPING RESTRICTIONS

ROAD & HIGHWAY, & CURB INLET).

SEE DRAWING NO. 7001-110-065.

N-12 HP, & PVC SEWER (4" - 24").

PER ASTM A536 GRADE 70-50-05.

(5) ADAPTER ANGLES

VARIABLE 0° - 360°

ACCORDING TO PLANS

(7) INTEGRATED DUCTILE IRON

FRAME & SOLID COVER

TO MATCH BASIN O.D.

PVC SURFACE DRAINAGE INLETS SHALL INCLUDE THE DRAIN BASIN TYPE AS INDICATED ON THE CONTRACT DRAWING AND REFERENCED WITHIN THE CONTRACT SPECIFICATIONS. THE DUCTILE IRON GRATES FOR EACH OF THESE FITTINGS ARE TO BE CONSIDERED AN INTEGRAL PART OF THE SURFACE DRAINAGE INLET AND SHALL BE FURNISHED BY THE SAME MANUFACTURER. THE SURFACE DRAINAGE INLETS SHALL BE AS MANUFACTURED BY NYLOPLAST A DIVISION OF ADVANCED DRAINAGE SYSTEMS, INC., OR PRIOR APPROVED EQUAL.

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NYLOPLAST DRAIN BASIN WITH WEIR

(6) VARIOUS TYPES OF INLET & OUTLET ADAPTERS

AVAILABLE: 4" - 30" FOR CORRUGATED HDPE

(ADS N-12/HANCOR DUAL WALL, ADS/HANCOR

PVC DWV (EX: SCH 40), PVC C900/C905,

CORRUGATED & RIBBED PVC

SINGLE WALL), N-12 HP, PVC SEWER (EX: SDR 35),

DRILL 3-1/2" DIAMETER

STRUCTURE TO ALLOW

THE BACKFILL MATERIAL SHALL BE CRUSHED STONE OR OTHER

GRANULAR MATERIAL MEETING THE REQUIREMENTS OF CLASS I,

BEDDING & BACKFILL FOR SURFACE DRAINAGE INLETS SHALL BE

PLACED & COMPACTED UNIFORMLY IN ACCORDANCE WITH ASTM D2321.

CLASS II, OR CLASS III MATERIAL AS DEFINED IN ASTM D2321.

RECIDUAL WATER TO

ESCAPE.

HOLES AT BOTTOM OF WEIR

HIGH-FLOW/SECONDARY OUTLET

SIDE SECTION & TOP VIEW:

ENLARGED TO SHOW DETAIL

(1) 24" - 30"

DRAIN BASIN BODY

INLET PIPE

REVISED BY NMH PROJECT NO NAME

FIRST-FLUSH

OUTLET

BUFORD, GA 30518

PHN (770) 932-2443

4" MIN ON 12" - 24"

6" MIN ON 30"

ASPHALT ABOVE

CONCRETE SLAB

DRAIN BASIN

INLINE DRAIN

Nyloplast FAX (770) 932-2490

DRAIN BASIN WITH WEIR

QUICK SPEC INSTALLATION DETAIL

7004-110-058


24" - 30" FRAME &


SOLID COVER

THE DRAIN BASINS REQUIRED FOR THIS CONTRACT SHALL BE MANUDACTURED FROM PVC PIPE STOCK, UTILIZING A THERMOFORMING PROCESS TO REFORM THE PIPE STOCK TO THE SPECIFIED CONFIGURATION. THE DRAINAGE PIPE CONNECTION STUBS SHALL BE MANUFACTURED FROM PVC PIPE STOCK AND DROMED TO PROVIDE A WATERTIGHT CONNECTION WITH THE SPECIFIED PIPE SYSTEM. THIS JOINT TIGHTNESS SHALL CONFORM TO ASTM F477. THE PIPE BELL SPIGOT SHALL BE JOINED TO THE MAIN BODT OF THE DRAIN BASIN OR CATCH BASIN. THE RAW MATERIAL USED TO MANUFACTURE THE PIPE STOCK THAT IS USED TO MANUFACTURE THE MAIN BODY AND PIPE STUBS OF THE SURFACE DRAINAGE INLETS SHALL CONFORM TO ASTM D1784 CELL CLASS 12454.

THE GRATES AND FRAMES FURNISHED FOR ALL SURFACE DRAINAGE INLETS SHALL BE DUCTILE IRON FOR SIZES 8", 10", 12", 15". 18", 24" AND 30" AND SHALL BE MADE SPECIFICALLY FOR EACH BASIN SO AS TO PROVIDE A ROUND BOTTOM FLANGE THAT CLOSELY MATCHES THE DIAMETER OF THE SURFACE DRAINAGE INLET. GRATES FOR DRAIN BASINS SHALL BE CAPABLE OF SUPPORTING VARIOUS WHEEL LOADS AS SPECIFIED BY NYLOPLAST. 12" AND 15" SQUARE GRATES WILL BE HINGED TO THE FRAME USING PINS. DUCTILE IRON USED IN THE MANUFACTURE OF THE CASTINGS SHALL CONFORM TO ASTM A536 GRATE 70-50-05. GRATES AND COVERS SHALL BE PROVIDED PAINTED BLACK.

INSTALLATION
THE ESPECIFIED PVC SURFACE DRAINAGE INLET SHALL BE INSTALLED USING CONVENTIONAL FLEXIBLE PIPE BACKFILL MATERIALS AND PROCEDURES. THE BACKFILL MATERIAL SHALL BE CRUSHED STONE OR OTHER GRANULAR MATERIAL MEETING THE REQUIREMENTS OF CLASS 1, CLASS 2, OR CLASS 3 MATERIAL AS DEFINED IN ASTM D 2321. BEDDING AND BACKFILL FOR SURFACE DRAINAGE INLETS SHALL BE WELL PLACED AND COMPACTED UNIFORMLY IN ACCORDANCE WITH ASTM D2321. THE DRAIN BASIN BODY WILL BE CUT AT THE TIME OF THE FINAL GRADE. NO BRICK, STONE OR CONCRETE BLOCK WILL BE REQUIRED TO SET THE GRATE TO THE FINAL GRADE HEIGHT. FOR LOAD RETED INSTALLATIONS, A CONCRETE SLAB SHALL BE POURED UNDER AND AROUND THE GRATE AND FRAME. THE CONCRETE SLAB MUST BE DESIGNED TAKING INTO CONSIDERATION LOCAL SOIL CONDITIONS, TRAFFIC LOADING, AND OTHER APPLICABLE DESIGN FACTORS. FOR OTHER INSTALLATION CONSIDERATIONS SUCH AS MIGRATION OF FINES, GROUND WATER, AND SOFT FOUNDATIONS REFER TO ASTM D2321 GUIDELINES.

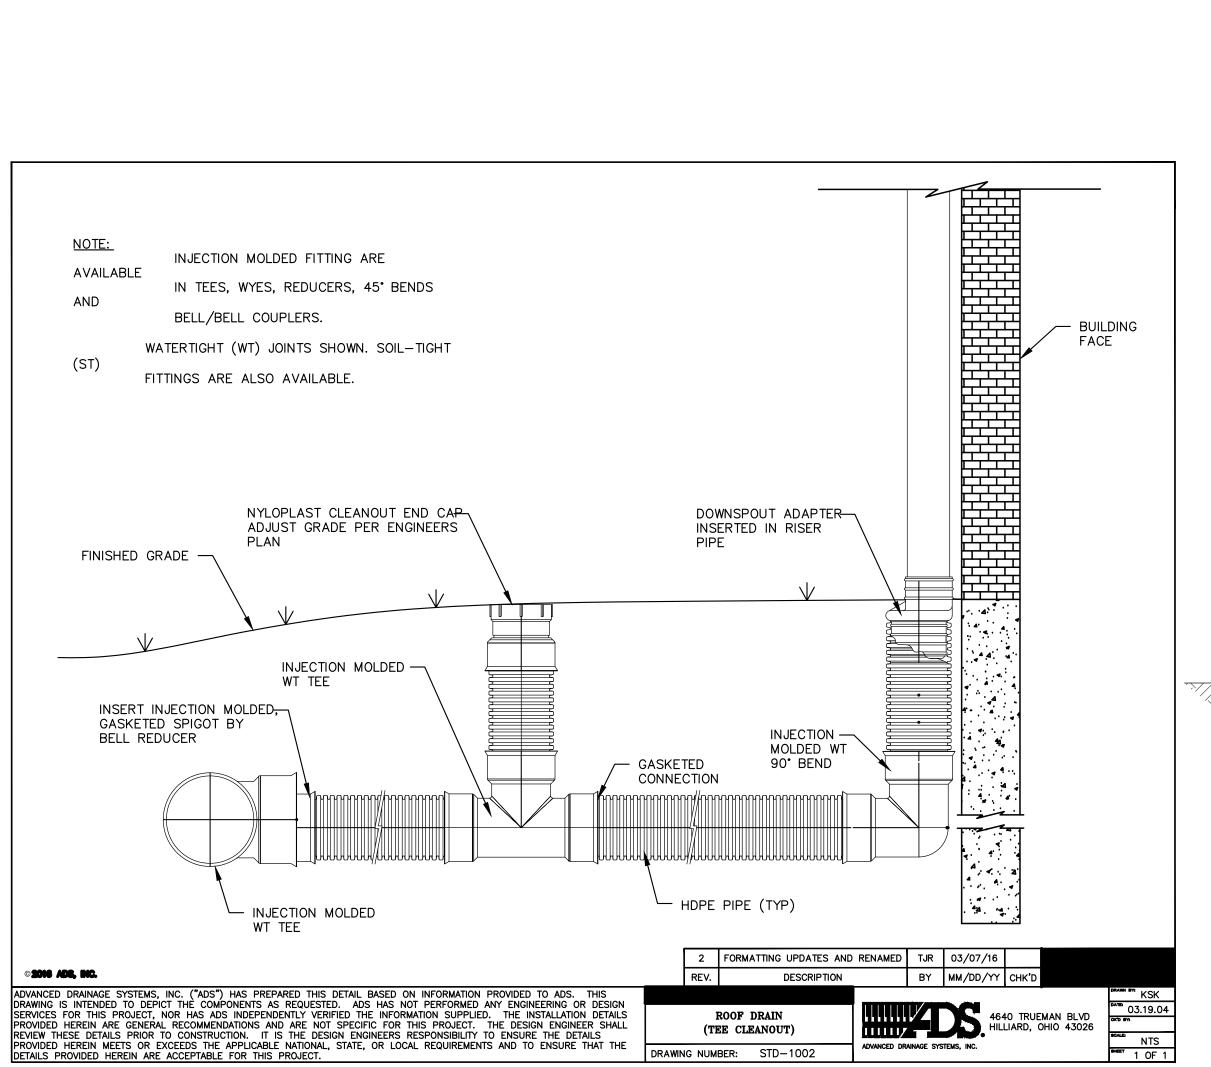

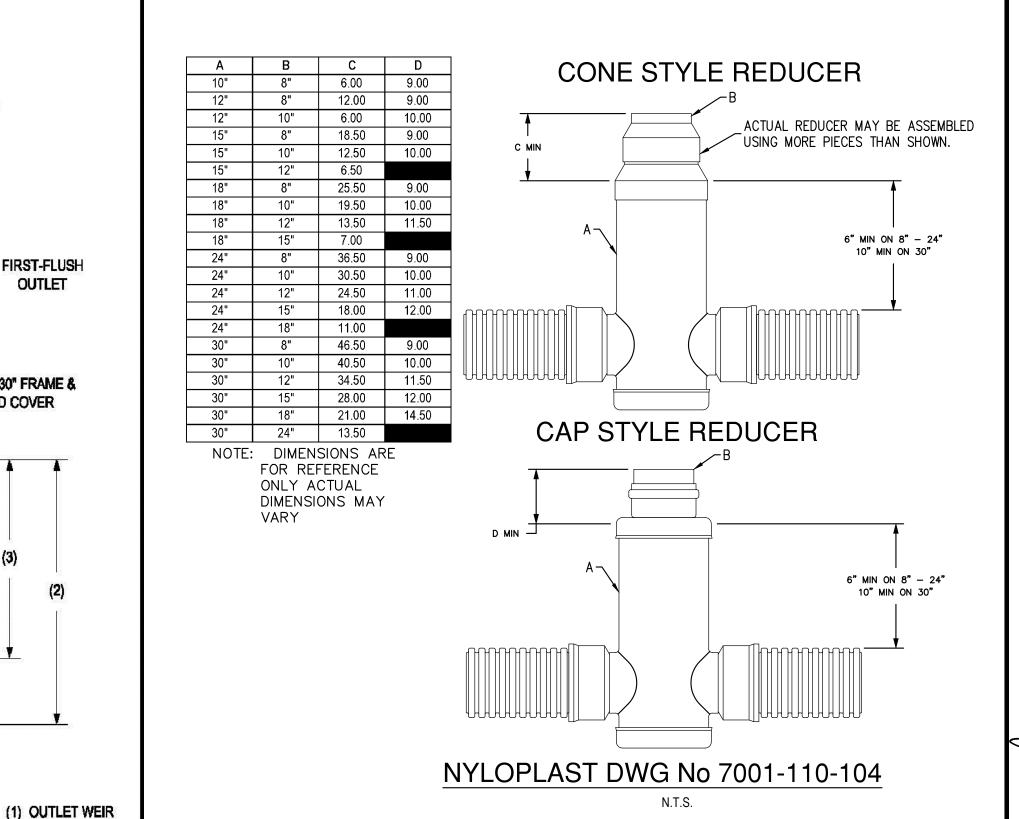

\ MALDONADO-CAMOU

2929 n central ave

oneil.t@owp.com

602.257.1764 t

602.257.9029 f

www.owp.com

phoenix arizona 85012

CLIENT CONTACT Dennis Roehler 9288 E. San Salvador Dr. Scottsdale, AZ 85258 480.484.8503 t

PROJECT NO. DATE OF ISSUE 10.10.19 050641-01-001 REVISION NO.

DATE 12.10.19

PROJECT TEAM DRAWN BY

PROJECT PHASE PERMIT SE

SHEET CONTENTS **GRADING DETAILS**

UNIFORMLY IN ACCORDANCE WITH ASTM ACCORDANCE WITH ASTM D2321. NYLOPLAST DWG No 7001-110-111

TRAFFIC LOADS: CONCRETE SLAB DIMENSIONS ARE FOR GUIDELINE PURPOSES ONLY. ACTUAL CONCRETE SLAB MUST BE DESIGNED TAKING INTO CONSIDERATION LOCAL SOIL CONDITIONS. TRAFFIC LOADING, & OTHER APPLICABLE DESIGN FACTORS. SEE DRAWING NO. 7001-110-111 FOR NON TRAFFIC INSTALLATION. (3) VARIABLE SUMP DEPTH ACCORDING TO PLANS (6" MIN. ON 12" - 24", 10" MIN. ON 30"BASED ON MANUFACTURING REQ.) THE BACKFILL MATERIAL SHALL BE CRUSHED STONE OR OTHER GRANULAR MATERIAL MEETING THE REQUIREMENTS OF CLASS I, CLASS II, OR CLASS III MATERIAL AS DEFINED IN ASTM D2321. BEDDING & BACKFILL FOR SURFACE DRAINAGE INLETS SHALL BE PLACED & COMPACTED UNIFORMLY IN ACCORDANCE WITH ASTM D2321. 5. ADAPTERS CAN BE MOUNTED 0° TO 360°. TO DETERMINE MINIMUM ANGLE BETWEEN ADAPTERS SEE DRAWING NO. 7001-110-012. 6. 12" - 24" PEDESTRIAN GRATES SHALL MEET H-10 LOAD RATING. 30" PEDESTRIAN GRATE SHALL MEET H-20 LOAD RATING (SEE 3130 VERONA AVE BUFORD, GA 30518 PHN (770) 932-2443

-18" MIN WIDTH GUIDELINE

4" MIN ON 8"-24"

8" MIN THICKNESS GUIDELINE

©2013 NYLOPLAST DWG SIZE A SCALE 1:40 SHEET 1 OF 1 DWG NO. 7001-110-192 DRAWING NUMBER: STD-1002 REV E

Nyloplast[®] FAX (770) 932-2490 www.nyloplast-us.com

24 IN DRAIN BASIN QUICK SPEC INSTALLATION

4" MIN ON 8" - 24" 6" MIN ON 30"

TOP SOIL-

INSTALL NYLOPLAST SUMP, INSERT ACCESSORY TO ELIMINATE BASIN SUMP PER MANUFACTURER

GRATE/COVER-

SPECIFICATIONS

DRAIN BASIN

THE BACKFILL MATERIAL SHALL BE CRUSHED STONE OR OTHER GRANULAR MATERIAL MEETING THE REQUIREMENTS OF CLASS I, CLASS II, OR CLASS III -MATERIAL AS DEFINED IN ASTM D2321. BEDDING & BACKFILL FOR SURFACE DRAINAGE INLETS SHALL BE PLACED & COMPACTED UNIFORMLY IN

SHALL BE PLACED & COMPACTED

ASPHALT INSTALLATION

INSTALL NYLOPLAST SUMP, INSERT

ACCESSORY TO ELIMINATE BASIN

SUMP PER MANUFACTURER

SPECIFICATIONS

NYLOPLAST DWG No 7001-110-188

NON TRAFFIC INSTALLATION

STRUCTURE SIZE

18"

8" MIN THICKNESS

THE BACKFILL MATERIAL SHALL BE CRUSHED STONE OR OTHER GRANULAR MATERIAL MEETING THE REQUIREMENTS OF CLASS I, CLASS II, OR CLASS III MATERIAL LAS DEFINED IN ASTM D2321. BEDDING & BACKFILL FOR SURFACE DRAINAGE INLETS

ROAD & HIGHWAY

H-20 GRATE OPTIONS

N/A STANDARD SOLID 2X2 R&H N/A

N/A STANDARD SOLID 2X2 R&H 2X3 R&H

PEDESTRIAN | STANDARD | SOLID | 2X2 R&H | 2X3 R&H

PLACED & COMPACTED UNIFORMLY IN ACCORDANCE WITH ASTM D2321.

PURPOSES ONLY. ACTUAL CONCRETE SLAB MUST BE DESIGNED TAKING

INTO CONSIDERATION LOCAL SOIL CONDITIONS, TRAFFIC LOADING, & OTHER

INLINE DRAIN

1 - THE BACKFILL MATERIAL SHALL BE CRUSHED STONE OR OTHER

APPLICABLE DESIGN FACTORS.

GRANULAR MATERIAL MEETING THE REQUIREMENTS OF CLASS I,

CLASS II, OR CLASS III MATERIAL AS DEFINED IN ASTM D2321.

BEDDING & BACKFILL FOR SURFACE DRAINAGE INLETS SHALL BE

GRATE/COVER-


TRAFFIC LOADS: CONCRETE SLAB DIMENSIONS ARE FOR GUIDELINE

STANDARD | SOLID | 2X2 R&H | N/A

STANDARD | SOLID | 2X2 R&H | 2X3 R&H

WIDTH GUIDELINE


SHEET SHEET NO.

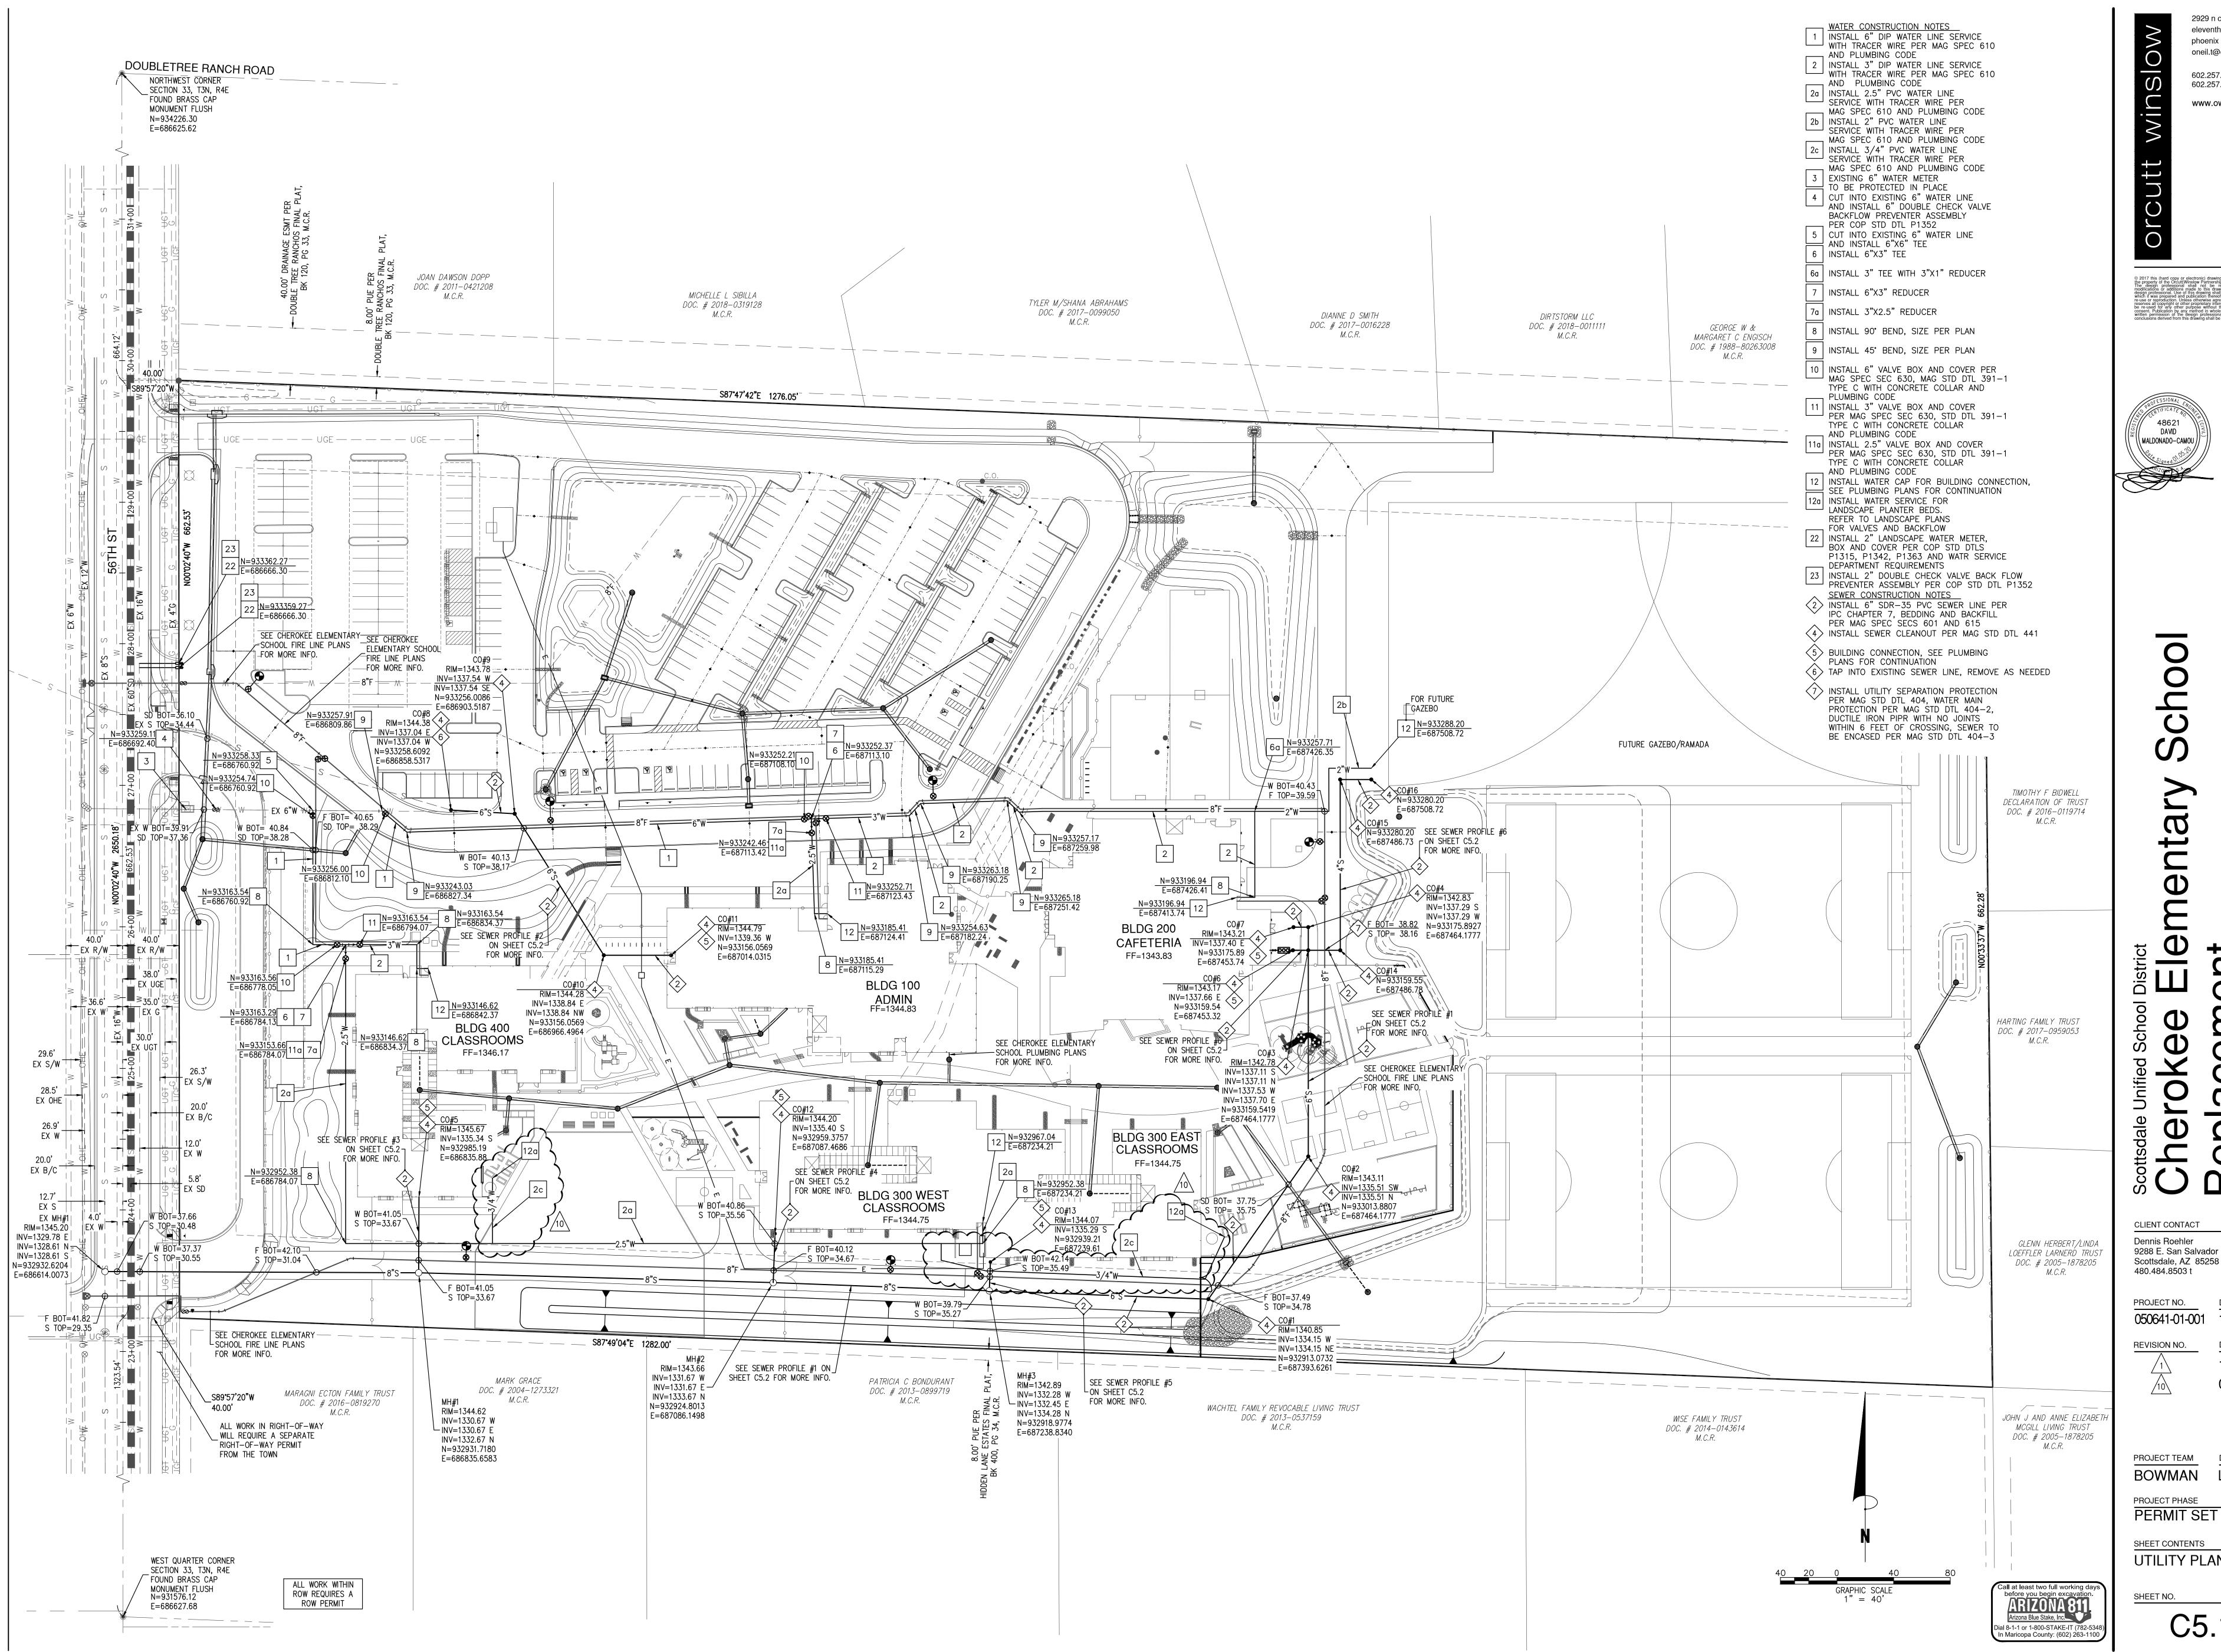

2929 n central ave phoenix arizona 85012 oneil.t@owp.com

602.257.1764 t 602.257.9029 f www.owp.com



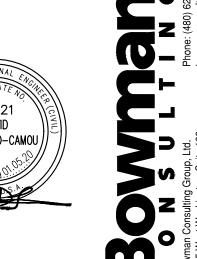

CLIENT CONTACT Dennis Roehler 9288 E. San Salvador Dr.

PROJECT NO. DATE OF ISSUE 050641-01-001 10.10.19 DATE REVISION NO.

12.10.19 03.25.20

PROJECT TEAM DRAWN BY BOWMAN LGR

PERMIT SET

SHEET CONTENTS UTILITY PLAN


SEWER PROFILE #6


SEWER PROFILE #3

SEWER PROFILE #4

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Sch mentar

CLIENT CONTACT Dennis Roehler 9288 E. San Salvador Dr.

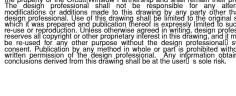480.484.8503 t PROJECT NO.

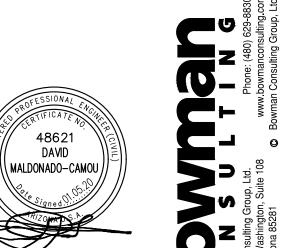DATE OF ISSUE 050641-01-001 10.10.19 DATE REVISION NO.

12.10.19 03.25.20

PROJECT TEAM DRAWN BY BOWMAN LGR

PROJECT PHASE PERMIT SET

SHEET CONTENTS SEWER PROFILES SHEET

SHEET NO.

SHT **21** OF **23**

CHEROKEE ELEMENTARY SCHOOL STORM WATER POLLUTION PREVENTION PLAN

PARADISE VALLEY, ARIZONA

A PORTION OF THE NORTHWEST QUARTER OF SECTION 33, TOWNSHIP 3 NORTH, RANGE 4 EAST OF THE GILA AND SALT RIVER BASE AND MERIDIAN, MARICOPA COUNTY, ARIZONA

DIANNE D SMITH

DOC. # 2017-0016228 M.C.R.

WACHTEL FAMILY REVOCABLE LIVING TRUST

DOC. # 2013-0537159

M. C. R.

DIRTSTORM LLC

<u>______</u>

SHEET INDEX

WISE FAMILY TRUST

DOC. # 2014-0143614

STORM WATER POLLUTION PREVENTION PLAN

GENERAL NOTES AND DETAIL SHEET

DOC. # 2018-0011111


GEORGE W & MARGARET C ENGISCH

DOC. # 1988-80263008

TYLER M/SHANA ABRAHAMS

DOC. # 2017-0099050

DOC. # 2013-0899719

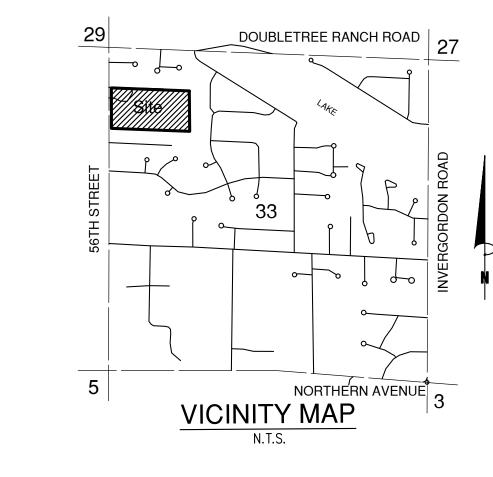

OWNER SCOTTSDALE UNIFIED SCHOOL DISTRICT. 9288 E SAN SALVADOR DRIVE SCOTTSDALE, ARIZONA 85258 CONTACT: DENNIS ROEHLER PHONE: 480.484.8503

ARCHITECT ORCUTT WINSLOW 2929 N CENTRAL AVENIE PHOENIX, ARIZONA 85012 PHONE: 602.257.1764 CONTACT: FATIMA GARCIA EMAIL: Garcia.f@owp.com

CIVIL ENGINEER BOWMAN CONSULTING 1295 W WASHINGTON ST SUITE 108 TEMPE, AZ 85281

STEVEN E/MARGARET

L MINARD TRUST

DOC. # 2002-0889169

DECLARATION OF TRUST

M. C.R.

HARTING FAMILY TRUST

DOC. # 2017-0959053 M. C. R.

GLENN HERBERT/LINDA

LOEFFLER LARNERD TRUST DOC. # 2005-1878205

JÓHN J AND ANNE ELIZABETH

MCGILL LIVING TRUST

KEY MAP

N.T.S.

DOC. # 2005-1878205

PHONE: 480.629.8830 ENGINEER: DAVID MALDONADO-CAMOU E-MAIL: dmaldonado@bowmanconsulting.com

CONSTRUCTION NOTES:

- NO WORK OF ANY KIND MAY COMMENCE CONSTRUCT RETENTION BASINS IN ACCORDANCE WITH THE GRADING & DRAINAGE PLAN. CONSTRUCTION BASINS SHALL ALSO ACT AS SEDIMENTATION BASINS DURING THE CONSTRUCTION PHASE.
- BASINS & CURB OPENINGS TO PREVENT SEDIMENTATION FROM ENTERING.

PLACE FIBER ROLLS, PER BMP SPC-1, OR GEOTEXTILE FABRIC AT CATCH

- STREETS SHALL BE SWEPT WHEN SEDIMENT IS PRESENT AND KEPT FREE OF TRACK OUT PER GH-6
- POST SIGN NEAR MAIN ENTRANCE WITH AZPDES AUTHORIZATION NUMBER, NAME AND TELEPHONE NUMBER OF CONTACT PERSON AND A BRIEF DESCRIPTION OF PROJECT.
- CONSTRUCT AND MAINTAIN A 30' WIDE x 50' LONG STABILIZED CONSTRUCTION ENTRANCE CONSISTING OF A MINIMUM OF 6" OF 1" TO 3" DIAMETER, WASHED, WELL GRADED GRAVEL OR CRUSHED ROCK PER BMP EC-5.
- CONSTRUCT AND MAINTAIN A SEDIMENT BERM ALONG LOW POINT OF THE SITE PER ADOT DTL E5 AND/OR SILT FENCE PER BMP SPC-5 TO PREVENT SEDIMENT FROM LEAVING THE SITE.
- CONSTRUCT AND MAINTAIN A MATERIALS STORAGE/CONSTRUCTION STAGING AND WASHOUT AREA PER BMP'S GH-2, GH-3. GH-4.
- CONSTRUCT AND MAINTAIN SEDIMENT WATTLE BARRIER ALONG THE PROPERTY LINE PER BMP SPC-1 TO PREVENT SEDIMENT FROM LEAVING THE SITE.
- APPLY DUST CONTROL MEASURES OVER DISTURBED AREAS PER BMP EC-7

SWPP CERTIFICATION

CERTIFY UNDER PENALTY OF LAW THAT THIS DOCUMENT AND ALL ATTACHMENTS WERE PREPARED UNDER MY DIRECTION OR SUPERVISION IN ACCORDANCE WITH A SYSTEM DESIGNED TO ASSURE THAT QUALIFIED PERSONNEL PROPERLY GATHER AND EVALUATE THE INFORMATION SUBMITTED. BASED ON MY INQUIRY OF THE PERSON OR PERSONS WHO MANAGE THIS SYSTEM, OR THOSE PERSONS DIRECTLY RESPONSIBLE FOR GATHERING THE INFORMATION, I BELIEVE THE INFORMATION SUBMITTED IS TRUE, ACCURATE, AND COMPLETE. I AM AWARE THAT THERE ARE SIGNIFICANT PENALTIES FOR SUBMITTING FALSE INFORMATION, INCLUDING THE POSSIBILITY OF FINE AND IMPRISONMENT. IN ADDITION I CERTIFY THAT THE PERMITTEE WILL COMPLY WITH ALL TERMS AND CONDITIONS STIPULATED IN GENERAL PERMIT NO. AZG2008-001 ISSUED BY THE DIRECTOR.

PRINTED NAME

SIGNATURE

CONTRACTOR CERTIFICATION

ACTING AS

REPRESENTATIVE, HAVING REVIEWED THIS STORM WATER MANAGEMENT PLAN (SWMP) AND ALL OF THE RELEVANT DOCUMENTS, DO HEREBY CERTIFY THAT UNDERSTAND ALL COMPONENTS OF THIS PLAN AND WILL PERFORM ALL REQUIRED INSPECTIONS AND MAINTENANCE ACTIVITIES AS REQUIRED.: AND THAT I WILL MAINTAIN ALL NECESSARY AND REQUIRED RECORDS AT THE JOB SITE AND UP TO DATE.

UTILITY COMPANY

CENTURY LINK

COX COMMUNICATIONS

ARIZONA PUBLIC SERVICE

CITY OF PHOENIX WATER

SOUTHWEST GAS CORPORATION

LEGAL DESCRIPTION

APN: 168-43-003

SITE INFO

NET ACREAGE= 19.431 ACRES

TOTAL AREA TO BE DISTURBED= 18.43 ACRES

BASE AND MERIDIAN, MARICOPA COUNTY ARIZONA:

GRANT DEED RECORDED IN DOCKET 1269, PAGE 73.

PROJECT DESCRIPTION

THE SOUTH HALF OF THE NORTHWEST QUARTER OF THE NORTHWEST QUARTER OF SECTION 33. TOWNSHIP 3 NORTH, RANGE 4 EAST OF THE GILA AND SALT RIVER

EXCEPT THE WEST 40 FEET THEREOF AS CONVEYED TO MARICOPA COUNTY BY

CHEROKEE ELEMENTARY SCHOOL IS A 19.43-ACRE PARCEL OF LAND LOCATED ON

8801 NORTH 56TH STREET IN PARADISE VALLEY, ARIZONA. THE SITE IS ZONED

NO WORK OF ANY KIND MAY OMMENCE UNTIL ALL STORM WATER POLLUTION BMPS ARE INSTALLED, INSPECTED AND APPROVED BY THE TOWN.

SEDIMENTATION CONTROL DEVICES (SILT BARRIERS) SHALL REMAIN IN PLACE AFTER DEMOLITION IS COMPLETE. SEDIMENTATION CONTROL DEVICES SHALL BE INSPECTED MONTHLY, AFTER EACH RAIN EVENT AND MAINTAINED AS NEEDED TO BE KEPT IN PROPER WORKING ORDER BY PERMIT APPLICANT AND/OR OWNER.

SEDIMENTATION CONTROL DEVICE INSPECTION LOG SHALL BE MAINTAINED BY

FOR REVIEW AND TO DETERMINE ANY POTENTIAL CONFLICTS.

EXISTING HYDRANT TO BE -WATER SOURCE FOR POLLUTION APPLICANT AND/OR OWNER AND MADE AVAILABLE TO THE TOWN UPON REQUEST. PREVENTION CONTROL

COMPANY CONTACT

ESTHER MEDINA - 480.768.4474

DATE SUBMITTED

MARAGNI ECTON FAMILY TRUST

DOC. # 2016-0819270

MARK GRACE

DOC. # 2004-1273321

LEGEND

CONSTRUCTION NOTE CALLOUT

PROPOSED DRAINAGE PATTERN

DUST CONTROL

ULTIMATE STORM OUTFALL

SEDIMENT WATTLE BARRIER

---- FILTER BARRIER

STABILIZED CONSTRUCTION ENTRANCE

JOAN DAWSON DOPP

DOC. # 2011-0421208

MICHELLE L SIBILLA

DOC. # 2018-0319128

 \sim THIS SET OF CONSTRUCTION PLANS HAVE BEEN SUBMITTED TO THE FOLLOWING UTILITY COMPANIES ALL WORK WITHIN ROW REQUIRES A ROW PERMIT HOPE OLGVIN - 480.730.3845 KEN DEGRAFFENREID – 623.328.3423 CYNTHIA KEE - 602.371.7667



phoenix arizona 85012 oneil.t@owp.com

602.257.9029 f

www.owp.com

CLIENT CONTACT Dennis Roehler 9288 E. San Salvador Dr. Scottsdale, AZ 85258

480.484.8503 t

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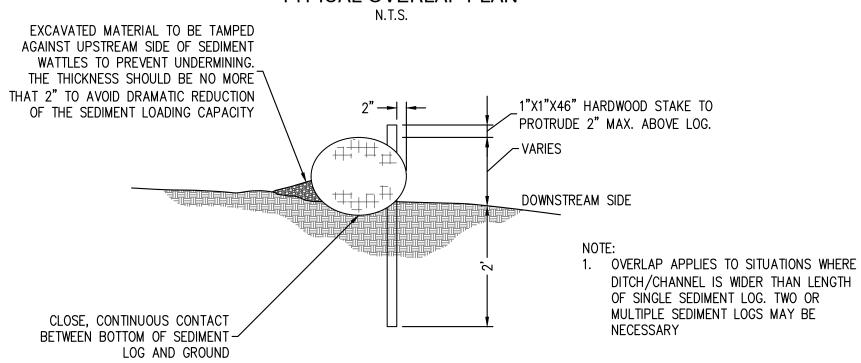
PROJECT TEAM DRAWN BY BOWMAN LGR

PROJECT PHASE PERMIT SET

SHEET NO.

SHEET CONTENTS STORM WATER POLLUTION PREVENTION PLAN

TYPICAL OVERLAP PLAN



DETAIL SPC-1 SEDIMENT WATTLE/LOG INSTALLATION N.T.S.

GH-4: DESIGNATED WASHDOWN AREA

PCC AND AC WASTES

- PCC AND AC WASTE SHOULD NOT BE ALLOWED TO ENTER STORM DRAINS OR WATER COURSES. INSTEAD, PCC AND AC WASTE SHOULD BE COLLECTED AND PROPERLY DISPOSED OF OUTSIDE THE
- HIGHWAY RIGHT-OF-WAY OR PLACED IN A TEMPORARY CONCRETE WASHOUT STRUCTURE. INSTALL A SIGN ADJACENT TO EACH TEMPORARY CONCRETE WASHOUT STRUCTURE TO INFORM
- CONCRETE EQUIPMENT OPERATORS TO UTILIZE THE INSTALLED STRUCTURES. A FOREMAN AND/OR CONSTRUCTION SUPERVISOR SHOULD MONITOR ONSITE CONCRETE WORKING
- TASK, SUCH AS SAWCUTTING, CORING, GRINDING AND GROOVING TO ENSURE PROPER METHODS ARE SAWCUTTING RESIDUE SHOULD NOT BE ALLOWED TO FLOW ACROSS THE PAVEMENT, AND SHOULD NOT
- BE LEFT ON THE SURFACE OF THE PAVEMENT. VACUUM SLURRY RESIDUE AND DISPOSE IN A TEMPORARY FACILITY AND ALLOW SLURRY TO DRY. DISPOSE OF DRY SLURRY RESIDUE IN ACCORDANCE WITH GH-2: SOLID WASTE MANAGEMENT.
- SIMILARLY, RESIDUE FROM GRINDING OPERATIONS SHOULD BE PICKED UP BY MEANS OF A VACUUM ATTACHMENT TO THE GRINDING MACHINE.

ONSITE TEMPORARY CONCRETE WASHOUT FACILITY PROCEDURES

- TEMPORARY CONCRETE WASHOUT FACILITIES SHOULD BE LOCATED A MINIMUM IF 50 FEET FROM STORM DRAIN INLETS, OPEN DRAINAGE FACILITIES, AND WATER COURSES, UNLESS DETERMINED
- INFEASIBLE BY THE SITE SUPERVISOR, EACH FACILITY SHOULD BE LOCATED AWAY FROM CONSTRUCTION TRAFFIC OR ACCESS AREAS TO PREVENT DISTURBANCE OR TRACKING. TEMPORARY CONCRETE WASHOUT FACILITIES SHOULD BE CONSTRUCTED ABOVE GRADE OR BELOW
- GRADE AT THE OPTION OF THE CONTRACTOR AND HAVE SUFFICIENT QUANTITY AND SIZE TO CONTAIN ALL LIQUID AND CONCRETE WASTE GENERATED BY WASHOUT OPERATIONS.
- PERFORM WASHOUT CONCRETE MIXER TRUCKS IN DESIGNATED AREAS ONLY. A SIGN SHOULD BE INSTALLED ADJACENT TO EACH WASHOUT FACILITY TO INFORM CONCRETE EQUIPMENT OPERATORS TO UTILIZE THE PROPER FACILITIES.
- WASH CONCRETE ONLY FROM MIXER TRUCK CHUTES INTO APPROVED CONCRETE WASHOUT FACILITY. WASHOUT MAY BE COLLECTED IN AN IMPERMEABLE BAG FOR DISPOSAL

ABOVE GRADE TEMPORARY CONCRETE WASHOUT STRUCTURE

- ABOVE GRADE TEMPORARY CONCRETE WASHOUT STRUCTURES SHOULD HAVE A MINIMUM LENGTH AND WIDTH OF 10 FEET OR LARGER TO PROVIDE SUFFICIENT VOLUME TO CONTAIN ALL LIQUID AND CONCRETE WASTE GENERATED BY WASHOUT OPERATIONS. IF DEEMED NECESSARY, THE LENGTH AND WIDTH OF THE WASHOUT STRUCTURE MAY BE EXPANDED FOR MORE CAPACITY.
- STRAW BALES, WOOD STAKES, AND SANDBAG MATERIALS SHOULD CONFORM TO THE SPECIFICATIONS IN SPC-1: ORGANIC FILTER BARRIER AND SPC-2: SAND BAG BARRIER.
- PLASTIC LINING MATERIAL SHOULD BE A MINIMUM OF 10-MIL POLYETHYLENE SHEETING AND SHOULD BE FREE OF HOLES, TEARS OR OTHER DEFECTS THAT COMPROMISE THE IMPERMEABILITY OF THE MATERIAL.

BELOW GRADE TEMPORARY CONCRETE WASHOUT STRUCTURE

- BELOW GRADE TEMPORARY CONCRETE WASHOUT SHOULD HAVE A MINIMUM LENGTH AND WIDTH OF 10 FEET OR LARGER TO PROVIDE SUFFICIENT VOLUME TO CONTAIN ALL LIQUID AND CONCRETE WASTE GENERATED BY WASHOUT OPERATIONS. IF DEEMED NECESSARY, THE LENGTH AND WIDTH OF THE WASHOUT STRUCTURE MAY BE EXPANDED FOR MORE CAPACITY.
- PLASTIC LINING MATERIAL SHOULD BE A MINIMUM OF 10-MIL POLYETHYLENE SHEETING AND SHOULD BE FREE OF HOLES, TEARS OR OTHER DEFECTS THAT COMPROMISE THE IMPERMEABILITY OF THE MATERIAL.
- ENSURE THAT THE SOIL BASE IF FREE OF ROCKS OR OTHER DEBRIS THAT MAY CAUSE TEARS OR HOLES IN THE PLASTIC LINING MATERIAL. REMOVAL OF TEMPORARY CONCRETE WASHOUT FACILITIES. • WHEN TEMPORARY CONCRETE WASHOUT FACILITIES ARE NO LONGER REQUIRED FOR THE WORK, AS DETERMINED BY THE SITE SUPERVISOR, HARDENED CONCRETE SHOULD BE BROKEN UP, REMOVED, AND HOLES, DEPRESSIONS OR OTHER GROUND DISTURBANCE CAUSED BY THE REMOVAL OF THE TEMPORARY CONCRETE WASHOUT FACILITIES SHOULD BE BACKFILLED.

RECOMMENDED MAINTENANCE AND INSPECTION

ENSURE PROPER METHODS ARE EMPLOYED.

 MONITOR ON SITE CONCRETE WASTE STORAGE AND DISPOSAL PROCEDURES AT LEAST WEEKLY. MONITOR CONCRETE WORKING TASKS, SUCH AS SAW CUTTING, CORING, GRINDING AND GROOVING TO


Road sweeping


Courtesy of Douglas County

Road Sweeping/Trackout

Cleaning Photos

BMP GH-6

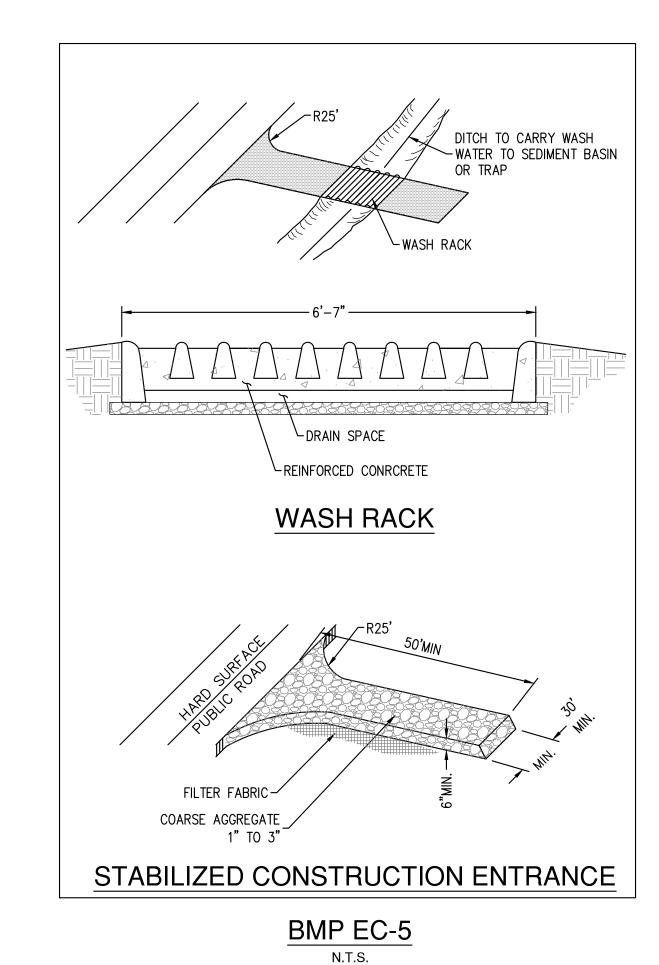

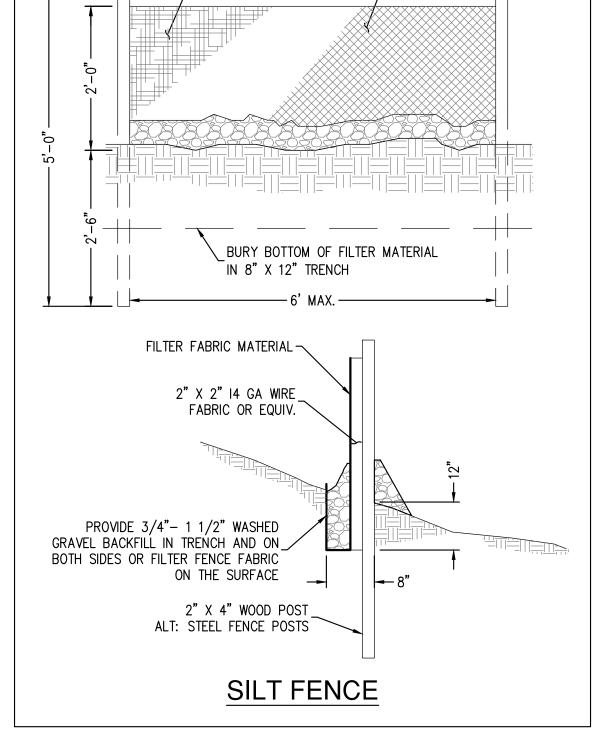

2" X 4" WOOD POST, STANDARD OR BETTER OR

FILTER FABRIC MATERIAL 60"WIDE ROLLS. _USE STAPLES OR WIRE RINGS TO ATTACH

2" X 2" I4 GA WIRE

FABRIC OR EQUIV.

EQUAL ALTERNATE: STEEL FENCE POST

FABRIC TO WIRE


BMP DETAIL SPC-5 N.T.S.

EC-7: DUST CONTROL							
TYPES	FUNCTIONAL MECHANISM	ADVANTAGES	LIMITATIONS				
FRESH WATER	MOISTURE WETS PARTICLES,THEREBY INCREASING THEIR MASS AND BINDING THEM TOGETHER	USUALLY READILY AVAILABLE, LOW MATERIAL COST, AND EASY TO APPLY	FREQUENT LIGHT APPLICATIONS MAY BE NECESSARY DURING HOT DRY WEATHER AND CAN BE LABOR INTENSIVE. OVER APPLICATION MAY RESULT IN LOSS IN TRACTION, EROSION, OR POINTS OF ROAD FAILURE.				
SYNTHETIC POLYMER	BIND SOIL PARTICLES TOGETHER BY FORMING A POLYMERIZING MATRIX; A FUNCTION SIMILAR TO ADHESIVES	APPLICABLE TO A RANGE OF EMISSION SOURCES AND FUNCTION WELL IN SANDY SOIL CONDITIONS. SOME TYPES ALLOW SEEDED VEGETATION TO GROW THROUGH THE POLYMER MATRIX	REQUIRE PROPER WEATHER AND TIME TO CURE. WATER REPELLENT. MAY BE SUBJECT TO UV(SUNLIGHT) DEGRADATION. APPLICABLE EQUIPMENT REQUIRES TIMELY CLEANING. THERE IS NO RESIDUAL EFFECTIVENESS AFTER REBLADING				

INSPECTION AND MAINTENANCE CHECKLIST						
ВМР	PERSON RESPONSIBLE	FREQUENCY OF INSPECTION				
STABILIZED ENTRANCE						
INLET PROTECTION						
SILT FENCE						
CONCRETE WASHOUT						




BMP SPC-1

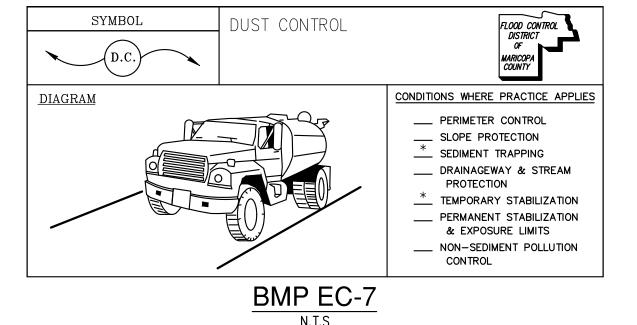



Equipment Maintenance GH-3 **Procedures Photos**

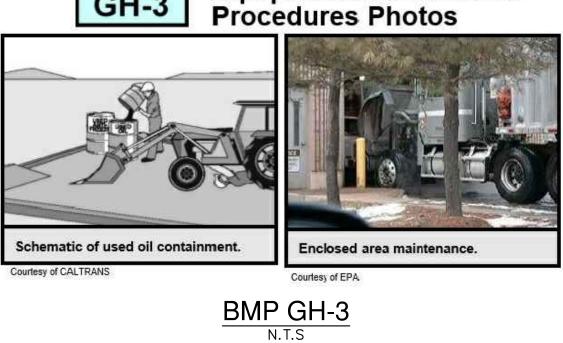



Call at least two full working days Dial 8-1-1 or 1-800-STAKE-IT (782-5348) In Maricopa County: (602) 263-1100



STORM GRATE-

∽FILTREXXR 8"-FILTERSOXXTM(TYP.)

CURBSIDE STORM GRATE CURBSIDE STORM GRATE

SECURE SOCK TO GRATE

WITH RUBBER TIE DOWNS

SPECIFICATIONS.

OPTION "B" PLAN VIEW

ALL MATERIAL TO MEET FILTREX

FILL TO MEET APPLICATION REQUIREMENTS.

SITE, AS DETERMINED BY ENGINEER.

FILTERSOXTM COMPOST/SOIL/ROCK/SEED

COMPOST MATERIAL TO BE DISPERSED ON

—2" X 2" WOODEN STAKE-

OPTION "A" PLAN VIEW

CATCH

BASIN

BMP SPEC-1

_FILTREXX® 8"

FILTERSOXXTM(TYP.)

rFILTREXX® 8"

-WIRE TIED FILTERSOXXTM

STANDARD PLAN VIEW

CATCH

BASIN

FILTERSOXXTM

FILTREXX® 8"¬

FILTERSOXXTM(TYP.)

FILTERSOXXTM(TYP.)

STORM GRATE


EXCESS SOCK MATERIAL TO-


TO STAKE AT BOTH ENDS

STANDARD SECTION CURBSIDE STORM GRATE SECTION

BE DRAWN IN AND TIED OFF



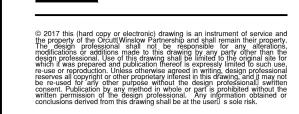

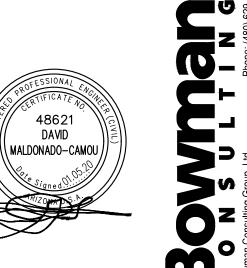

ntar (1)

CLIENT CONTACT Dennis Roehler 9288 E. San Salvador Dr. Scottsdale, AZ 85258 480.484.8503 t

PROJECT NO. DATE OF ISSUE 050641-01-001 10.10.19

DATE REVISION NO. 12.10.19

PROJECT TEAM BOWMAN

PROJECT PHASE PERMIT SET

SHEET CONTENTS

SHEET NO. C6.2

GENERAL NOTES AND **DETAILS SHEET**

SHT **23** OF **23**